YESHIVA NEW ACADEMY BUILDING PRELIMINARY AND FINAL SITE PLAN APPROVAL

BLOCK: 134 - LOT: 1


21 ROCKVIEW AVENUE, BOROUGH OF NORTH PLAINFIELD, SOMERSET COUNTY, NEW JERSEY


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SURVEY	BOUNDARY AND TOPOGRAPHIC SURVEY	NEWLINES ENGINEERING & SURVEY

REQUIRED PERMITS

- SOIL EROSION & SEDIMENT CONTROL PERMIT
- NJPDES GENERAL PERMIT FOR STORMWATER DISCHARG ASSOCIATED WITH CONSTRUCTION ACTIVITY - 5G3
- NEW JERSEY AMERICAN WATER (NJAW)



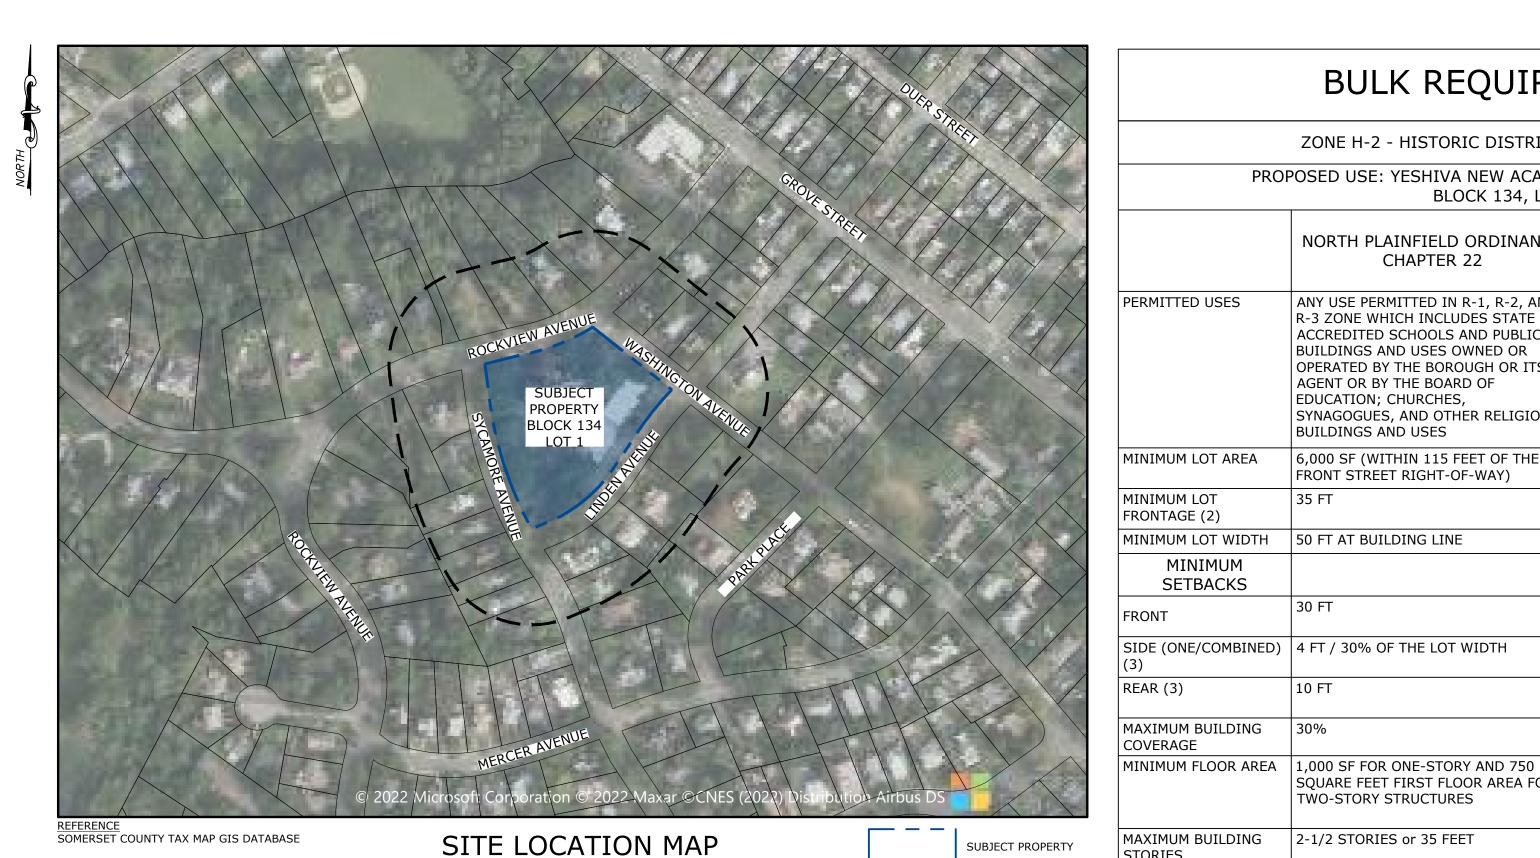

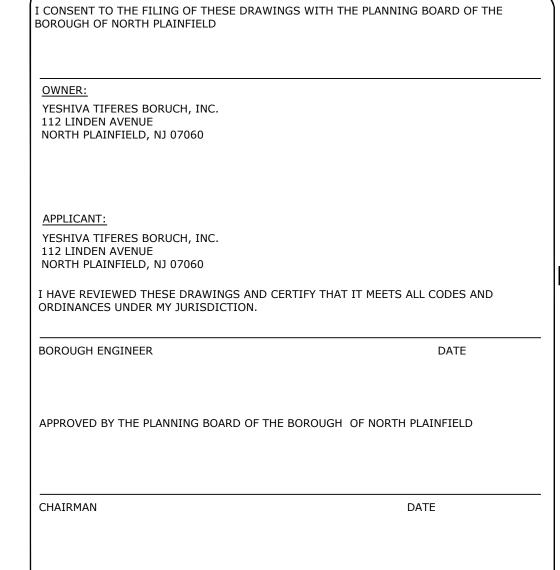PROJECTED WATER DEMAND DAILY SEWER NUMBER

OF UNITS NJAC 7:10-12.6

SECRETARY

(WITH CAFETERIA) 79 STUDENTS 15 GPD/STUDENT

* NO NJDEP WEP PERMIT REQUIRED. ADDITIONALLY THERE IS NO INCREASE IN STUDENT POPULATION SO AS SUCH THERE IS NO INCREASE IN WATER DEMAND FOR THE SITE, BUT THIS CALCULATION WAS PREPARED IN ACCORDANCE WITH N.J.A.C. 7:10-12.6.

PARKING CALCULATION

- ONE SPACE FOR EACH 200 SQUARE FEET OF GROSS FLOOR AREA UNLESS WAIVED BY THE PLANNING BOARD NO SCHOOL OR DORMITORY USE LISTED IN ORDINANCE
- EXISTING BUILDINGS ON SITE •• 36,193 GROSS SQUARE FEET
- •• REQUIRES 181 PARKING STALLS EXISTING STALLS ON SITE: 31 PARKING STALLS PROPOSED STALLS ON SITE: 27 PARKING STALLS (LOSE 4 STALLS BASED ON PROPOSED DEVELOPMENT)
- PROPOSED BUILDING •• 11,267 GROSS SQUARE FEET
- REQUIRES 56 PARKING STALLS
 TOTAL STALLS REQUIRED ON SITE: 237 PARKING STALLS

WAIVER REQUESTED BASED ON RESULTS OF TRAFFIC STUDY OADING CALCULATION

- SECTION 22-117.3 OFF-STREET LOADING SPACE REQUIREMENTS FOR ANY BUILDING OR PREMISES USED FOR COMMERCIAL OR INDUSTRIAL PURPOSES, INDOOR OR OUTDOOR SPACE FOR LOADING AND UNLOADING GOODS AND MATERIALS SHALL BE PROVIDED ON PREMISES WHENEVER THE AGGREGATE FLOOR AREA USED FOR SUCH PURPOSES IS 4,000 SQUARE FEET OR MORE, IN ACCORDANCE WITH THE FOLLOWING SCHEDULE:
- •• 4,000 TO 20,000 SQUARE FEET, ONE SPACE 20,000 TO 40,000 SQUARE FEET, TWO SPACES •• OVER 40,0000 SQUARE FEET, THREE SPACES
- NO OFF-STREET LOADING IS REQUIRED SINCE NO COMMERCIAL OR INDUSTRIAL USE IS PROPOSED.

PROJECTED SANITARY FLOW

FLOW PER FLOW NUMBER OF UNITS NJAC 7:14A-23

(WITH CAFETERIA) 79 STUDENTS 15 GPD/STUDENT 1,185 GPD

* NO NJDEP TWA PERMIT REQUIRED. ADDITIONALLY THERE IS NO INCREASE IN STUDENT POPULATION SO AS SUCH THERE IS NO INCREASE IN SANITARY FLOW OFF SITE, BUT THIS CALCULATION WAS PREPARED IN ACCORDANCE WITH N.J.A.C. 7:14A-23.

ZONE H-2 - HISTORIC DISTRICT RESIDENCE ZONE

BULK REQUIREMENTS

PROPOSED USE: YESHIVA NEW ACADEMY BUILDING (SCHOOL) BLOCK 134, LOT 1

	NORTH PLAINFIELD ORDINANCE CHAPTER 22	EXISTING (LOT 1)	PROPOSED (LOT 1)
PERMITTED USES	ANY USE PERMITTED IN R-1, R-2, AND R-3 ZONE WHICH INCLUDES STATE ACCREDITED SCHOOLS AND PUBLIC BUILDINGS AND USES OWNED OR OPERATED BY THE BOROUGH OR ITS AGENT OR BY THE BOARD OF EDUCATION; CHURCHES, SYNAGOGUES, AND OTHER RELIGIOUS BUILDINGS AND USES	SCHOOL/RELIGIOUS SCHOOL	SCHOOL/RELIGIOUS SCHOOL
MINIMUM LOT AREA	6,000 SF (WITHIN 115 FEET OF THE FRONT STREET RIGHT-OF-WAY)	96,630 SF	96,630 SF
MINIMUM LOT FRONTAGE (2)	35 FT	207.8 FT	207.8 FT
MINIMUM LOT WIDTH	50 FT AT BUILDING LINE	224.4 FT	224.4
MINIMUM SETBACKS			
FRONT	30 FT	16.2 FT (1)	30.6 FT
SIDE (ONE/COMBINED) (3)	4 FT / 30% OF THE LOT WIDTH	N/A	N/A
REAR (3)	10 FT	N/A	N/A
MAXIMUM BUILDING COVERAGE	30%	22.3% (21,552 SF)	29.6% (28,612 SF)

399 SF (EX. 1-STORY | EXISTING BLDG: FRAME BUILDING) 4,361 SF PROPOSED: 7,739 SF

EXISTING: 3-STORY | PROPOSED BLDG:

(2-STORY BLDG)

STORIES (1) 2 STORIES / 34.67 FT TABLE KEY NO CHANGE NOT APPLICABLE PRE-EXISTING NON CONFORMING VARIANCE REQUIRED

PER SECTION 22-106A.4 OF THE NORTH PLAINFIELD ORDINANCE, IN THE H-2 HISTORIC DISTRICT RESIDENCE ZONE, ALL REQUIRED CONDITIONS OF R-2 RESIDENCE ZONE SHALL BE MET; PROVIDED, HOWEVER, THAT FOR TWO-FAMILY DWELLINGS, ALL REQUIRED CONDITIONS OF R-3 RESIDENCE ZONE SHALL BE MET.

THE PROJECT SITE FRONTS ON FOUR (4) STREETS. THE LEAST FRONTAGE IS ALONG WASHINGTON AVENUE. 3. THE PROJECT SITE FRONTS ON FOUR (4) STREETS AND THEREFORE HAS NO SIDE OR REAR YARDS.

SQUARE FEET FIRST FLOOR AREA FOR

TWO-STORY STRUCTURES

2-1/2 STORIES or 35 FEET

PROJECT DESCRIPTION

THE PROPOSED PROJECT CONSISTS OF A TWO-STORY 11,267 GROSS SQUARE FOOT YESHIVA NEW ACADEMIC BUILDING. THE NEW ACADEMIC BUILDING WILL BE LOCATED AT 21 ROCKVIEW AVENUE WHICH ALREADY CONTAINS EXISTING STRUCTURES ON SITE INCLUDING SCHOOL FACILITIES, HOUSING FOR STUDENTS, AND SIX APARTMENTS. THE PROPOSED BUILDING WILL NOT INCREASE ENROLLMENT OR STAFFING AND WILL CONSIST OF A DINING HALL, COMMERCIAL KITCHEN, AND A STUDY HALL AND LECTURE HALL. ADDITIONAL SITE IMPROVEMENTS INCLUDING SIDEWALKS, LIGHTING, LANDSCAPING, AND UTILITY AND STORMWATER MANAGEMENT

WAIVERS REQUESTED

SECTION 22-117.2b15 PARKING STALL REQUIREMENTS WAIVER REQUESTED IN ACCORDANCE WITH TRAFFIC ENGINEERING REPORT

LOT COVERAGE CALCULATIONS

ON-SITE IMPERVIOUS COVERAGE

28,612 SF **CONCRETE & PAVEMENT AREAS** 21,506 SF TOTAL ON-SITE IMPERVIOUS COVERAGE 50,118 SF

ON-SITE PERVIOUS COVERAGE

LAWN & OPEN SPACE 46,512 SF TOTAL PERVIOUS COVERAGE 46,512 SF

BUILDING COVERAGE

BUILDING = (28,612/96,630) X 100 = 29.6%

LOT COVERAGE

LOT COVERAGE = (50,118 / 96,630) X 100 = 51.9% TOTAL AREA OF DISTURBANCE = 0.54 ACRES

E 2 PROJECT MANAGEMENT LLC

N.J. ENGINEERING CERTIFICATE OF

AUTHORIZATION No. 24GA28118200

I CERTIFY THAT THESE PLANS HAVE BEEN

PREPARED UNDER MY SUPERVISION

SCHEDULE OF REVISIONS

DATE DESCRIPTION OF CHANGES

OWNER/APPLICANT

112 LINDEN AVENUE

YESHIVA TIFERES BORUCH, INC.

NORTH PLAINFIELD, NJ 07060

87 HIBERNIA AVENUE

ROCKAWAY, N.J. 07866

CHARLES J. STEWART, P.E., P.L.S. N.J. NO. 24GB03588400 REGISTERED PROFESSIONAL ENGINEER AND LAND SURVEYOR

YESHIVA NEW ACADEMY BUILDING

TAX LOT 1 BLOCK 134


21 ROCKVIEW AVENUE BOROUGH OF NORTH PLAINFIELD SOMERSET COUNTY, NJ

DRAWING TITLE

TITLE SHEET

CHECKED BY:	CS	DRAWN BY: ENS
SCALE:	AS NOTED	SHEET NO: 1 OF 15
PROJECT #: p-2	22-47-01	FIRST ISSUE: 8/24/2022

SP-100.00

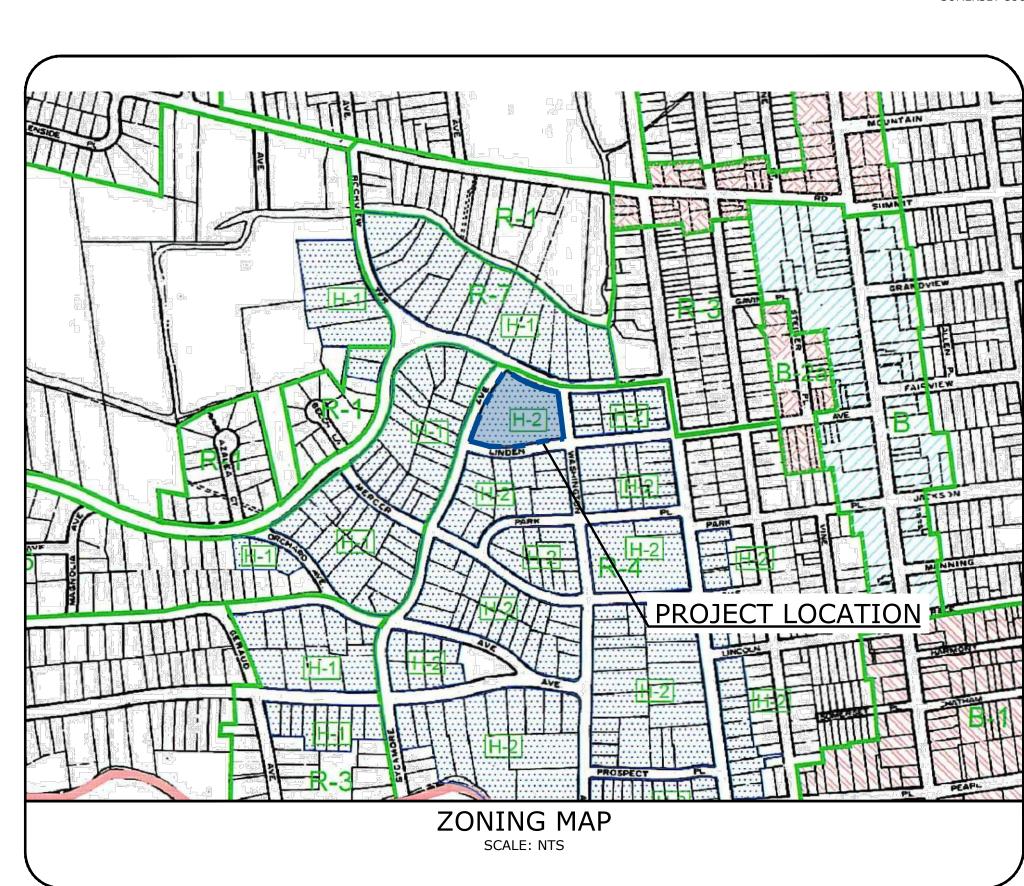

GENERAL NOTES

AND VEGETATION INTENDED TO REMAIN.

- BOUNDARY AND TOPOGRAPHIC INFORMATION AND EXISTING UTILITIES SHOWN HEREON WAS TAKEN FROM A MAP PREPARED BY NEWLINES ENGINEERING & SURVEY ENTITLED "BOUNDARY & TOPOGRAPHIC SURVEY BLOCK 134 - LOT 1, 21 ROCKVIEW AVENUE, NORTH PLAINFIELD BOROUGH, SOMERSET COUNTY, NEW JERSEY" DATED DECEMBER 6, 2021.
- 2. CONTRACTOR SHALL VERIFY THE LOCATION OF EXISTING UTILITIES IN THE FIELD PRIOR TO CONSTRUCTION. THIS SHALL INCLUDE EXCAVATING TEST PITS, IF NECESSARY. CONTRACTOR SHALL CALL FOR UTILITY MARK-OUT PRIOR TO ANY DEMOLITION OR CONSTRUCTION ACTIVITIES.
- 3. ALL SITE WORK SHALL BE PERFORMED IN ACCORDANCE WITH THE REQUIREMENTS OF THE BOROUGH OF NORTH PLAINFIELD.
- 4. CONNECTIONS TO EXISTING UTILITIES SHALL BE PERFORMED IN ACCORDANCE WITH THE REQUIREMENTS OF THE UTILITY COMPANY HAVING JURISDICTION.
- 5. CONTRACTOR SHALL NOTIFY THE OWNER AND ENGINEER OF FIELD CONDITIONS OR
- CONFLICTS THAT WOULD ADVERSELY IMPACT CONSTRUCTION AS PROPOSED ON THE PLANS.

 6. CONTRACTOR SHALL TAKE PRECAUTIONS TO AVOID DAMAGE TO EXISTING IMPROVEMENTS
- 7. ALL EXISTING ONSITE IMPROVEMENTS SHALL BE REMOVED UNLESS NOTED OTHERWISE.
- 8. E2 PROJECT MANAGEMENT LLC. ASSUMES NO RESPONSIBILITY FOR THE METHODS, TECHNIQUES OR PROCEDURES OF CONSTRUCTION, FOR SAFETY MEASURES OR PRECAUTIONS RELATED TO CONSTRUCTION, OR ANY FAILURE TO COMPLY WITH APPLICABLE LAWS, REGULATIONS, ORDINANCES OR CODES.
- 9. ANY STRUCTURES TO BE REMOVED SHALL HAVE EXCAVATIONS BACKFILLED WITH STRUCTURAL FILL AND PROPERLY COMPACTED, AS PER PROJECT SPECIFICATIONS.
- 10. PER FEMA MAP 34035C0181E, THE SUBJECT PROPERTY DOES NOT CONTAIN ANY LAND WITHIN A DELINEATED FLOOD HAZARD AREA.
- 11. NO CONSTRUCTION SHALL TAKE PLACE UNTIL A PRE-CONSTRUCTION CONFERENCE HAS BEEN HELD WITH THE BOROUGH ENGINEER. SUCH MEETING SHALL INCLUDE SUCH PERSONNEL AS THE BOROUGH ENGINEER MAY REQUIRE.
- 12. THE MAXIMUM PERMITTED SLOPE SHALL BE 3 HORIZONTAL TO 1 VERTICAL FOR ALL SITE GRADING.
- 13. ANY DISTURBED AREA THAT WILL BE LEFT EXPOSED FOR MORE THAN THIRTY (30) DAYS AND NOT SUBJECT TO CONSTRUCTION TRAFFIC SHALL IMMEDIATELY RECEIVE A TEMPORARY SEEDING. IF THE SEASON PROHIBITS TEMPORARY SEEDING, THE DISTURBED AREA WILL BE MULCHED WITH STRAW OR THEN HAY AND TACKED IN ACCORDANCE WITH THE NEW JERSEY STANDARDS. SEE SOIL EROSION AND SEDIMENT CONTROL NOTES FOR SEEDING SPECIFICATIONS.
- 14. ALL CONSTRUCTION SHOW HEREIN SHALL CONFORM TO MUNICIPAL/COUNTY STANDARD CONSTRUCTION DETAILS AND SPECIFICATIONS AND N.J. DEPT. OF TRANSPORTATION STANDARD SPECIFICATIONS FOR ROAD AND BRIDGE CONSTRUCTION, AS AMENDED, UNLESS SPECIFICALLY SHOWN OTHERWISE HEREIN. IN CASE OF CONFLICT, THE MORE RESTRICTIVE SHALL GOVERN. CONTRACTOR SHALL NOTIFY DESIGN ENGINEER OF ANY QUESTIONS REGARDING CONFLICTS.
- 15. HANDICAPPED RAMPS AND CURB CUTS WILL BE PROVIDED AT ALL INTERSECTIONS AND PEDESTRIAN CROSSINGS, AS PER DETAILS.
- 16. ANY DAMAGE TO THE RIGHT-OF-WAY MUST BE REPAIRED/INSTALLED TO EQUAL STANDARDS.
- 17. ALL IMPROVEMENTS WITHIN THE BOROUGH OF NORTH PLAINFIELD'S RIGHT OF WAY SHALL CONFORM TO THE BOROUGH OF NORTH PLAINFIELD'S STANDARDS.

UTILITY NOTES

- 1. THE SUBJECT PROPERTY HAD NUMEROUS RESIDENTIAL BUILDINGS. ALL THE HISTORICAL BUILDINGS HAVE BEEN DEMOLISHED. HOWEVER, THE SITE MOST LIKELY HAS SUBSURFACE OBSTRUCTIONS SUCH AS FOUNDATIONS, PITS, SLABS, AND UTILITY LINES. CONTRACTOR SHALL TAKE APPROXIMATE PRECAUTIONS.
- 2. GAS, ELECTRIC, TELEPHONE, WATER AND CABLE LINES MAY BE INSTALLED BY THE RESPECTIVE UTILITY. THE EXACT LOCATION OF EACH MAIN SHALL BE COORDINATED BY THE OWNER/GENERAL CONTRACTOR AND SUBMITTED TO THE DESIGN ENGINEER FOR REVIEW PRIOR TO INSTALLATION.
- ALL NEW UTILITIES SHALL BE INSTALLED UNDERGROUND, EXCEPT WHERE OTHERWISE NOTED.
- 4. EXISTING INLETS SHALL BE RELOCATED AND/OR RESET TO MATCH TO THE NEW CURB LINE
- 5. ALL PROPOSED ELECTRICAL TRANSFORMERS SHALL BE LOCATED INSIDE A BUILDING OR ON A CONCRETE SLAB AS PER PSE&G STANDARDS..
- 6. DESIGN OF ELECTRICAL UTILITIES FROM THE ELECTRICAL POLES TO THE TRANSFORMERS INCLUDING PRIMARY CONDUITS, PULLBOXES, MANHOLES, AND TRANSFORMER VAULTS ARE PENDING PSE&G APPROVAL. PSE&G APPROVAL WILL BE FOUND ON SEPARATE DRAWINGS FROM THIS SET.
- 7. ALL RCP DRAINAGE PIPE SHALL MEET OR EXCEED THE REQUIREMENTS SPECIFICATION FOR ASTM C76 "STANDARD SPECIFICATION FOR REINFORCED CONCRETE CULVERT, STORM DRAIN, AND SEWER PIPE", LATEST VERSION, IN CONFORMANCE WITH THE FOLLOWING.
 -PIPES WITH COVER EQUAL TO OR LESS THAN 3 FT. SHALL BE CLASS IV PIPE
- -ALL PIPES SHALL UTILIZE A CLASS C WALL THICKNESS.
 -ALL PIPE REACHES SHALL BE CONSTRUCTED USING THE SAME CLASS AND WALL
- 8. ALL CATCH BASINS SHALL BE NJDOT TYPE "A", "B" OR "E".

-PIPES WITH COVER GREATER THAN 3 FT. SHALL BE CLASS III.

- 9. CONTRACTOR SHALL COORDINATE FIRE HYDRANT LOCATIONS WITH THE FIRE DEPARTMENT PRIOR TO INSTALLATION. A PLAN OF SAME SHALL BE SUBMITTED TO THE DESIGN ENGINEER.
- 10. SANITARY SEWER MANHOLE RIMS SHALL BE RESET TO PROPOSED NEW PAVEMENT GRADE AS REQUIRED.
- 11. EXISTING WATER VALVE AND GAS VALVE BOXES SHALL BE RESET TO PROPOSED NEW PAVEMENT GRADE AS REQUIRED.
- 12. A MINIMUM HORIZONTAL DISTANCE OF 10 FT OR A MINIMUM OF 18" VERTICAL DISTANCE IS REQUIRED BETWEEN SANITARY SEWER AND POTABLE WATER PIPING. IF EITHER OF THESE DISTANCES CANNOT BE ACHIEVED, THE SANITARY SEWER SHALL BE ENCASED IN CONCRETE AT THE CONFLICT LOCATION.
- 13. ALL WATER UTILITY INSTALLATIONS SHALL CONFORM TO THE LATEST AMERICAN WATER WORKS ASSOCIATION SPECIFICATIONS. WATER SYSTEMS SHALL BE INSTALLED PER THE NEW JERSEY PLUMBING CODE AND AS PER THE REQUIREMENTS OF AMERICAN WATER WORKS COMPANY.
- 14. ALL PROPOSED WATER MAINS, LOOPS, AND FIRE AND DOMESTIC WATER SERVICE SIZES SHOWN, WILL BE ADJUSTED AND SIZED BASED UPON THE RESULTS OF FIRE FLOW TESTS AND SUBSEQUENT DESIGN CALCULATIONS TO BE PROVIDED BY OTHERS.
- 15. SANITARY SEWER AND WATER MAIN DESIGN SHALL BE COORDINATED WITH MEP ENGINEERING DESIGN ONCE IT HAS BEEN DEVELOPED.

SOIL AND WASTE MANAGEMENT

1. SOIL, WASTE, SURFACE WATER, AND GROUNDWATER MANAGEMENT SHALL BE PERFORMED IN ACCORDANCE WITH LOCAL, STATE, AND FEDERAL REGULATIONS.

2. A SITE SPECIFIC HEALTH AND SAFETY PLAN (HASP) SHALL BE PREPARED, SUBMITTED AND IMPLEMENTED BY CONTRACTOR IN ACCORDANCE IN ACCORDANCE WITH ALL APPLICABLE HEALTH AND SAFETY REQUIREMENTS. THE HASP SHALL GOVERN ALL HEALTH AND SAFETY FACETS OF THE PROJECT CONSTRUCTION AND ENCOMPASS THE ACTIVITIES OF ALL PERSONS

3. THE CONTRACTOR SHALL PROVIDE PROTECTION AND ON-GOING MAINTENANCE OF THE TEMPORARY STOCKPILES OF SOIL AND OPEN EXCAVATIONS TO PREVENT THE INFILTRATION OF STORMWATER, DUSTING, EROSION AND UNAUTHORIZED CONTACT. THE CONTRACTOR SHALL BE RESPONSIBLE FOR THESE PROPER PROTECTION AND MAINTENANCE MEASURES UNTIL COMPLETION OF THE WORK AND ACCEPTANCE BY THE ENGINEER.

STORMWATER AND GROUNDWATER MANAGEMENT DURING SOIL EXCAVATION

- 1. THE CONTRACTOR SHALL PREPARE AND IMPLEMENT A STORMWATER AND GROUNDWATER MANAGEMENT AND CONTROL PLAN TO MANAGE SURFACE WATER AND GROUNDWATER. THE CONTRACTOR SHALL IDENTIFY ALL REQUIRED PERMITS ON THE MHP AND CONTRACTOR'S PROJECT SCHEDULE ALLOWING ADEQUATE TIME FOR SECURING ALL REQUIRED PERMITS IN TIME FOR CONSTRUCTION.
- 2. THE CONTRACTOR'S PLAN SHALL SPECIFY METHODS AND EQUIPMENT FOR COLLECTING, PUMPING, TREATING AND DISPOSING OF LIQUIDS GENERATED DURING STORM WATER CONTROL AND DEWATERING; MEASURES TO PREVENT STORM WATER RUN-ON AND RUN-OFF; DEWATERING OF EXCAVATIONS; DECONTAMINATING PERSONNEL AND EQUIPMENT; AND STORING FUELS AND CHEMICALS. THE CONTRACTOR'S PLAN SHALL ALSO IDENTIFY THE APPLICABLE PERMITTING, MONITORING AND REPORTING REQUIREMENTS.
- 3. STORM AND GROUND WATERS REMOVED FROM EXCAVATIONS IN AREAS OF POTENTIALLY CONTAMINATED SOILS OR GROUNDWATER SHALL BE PASSED THROUGH A TREATMENT SYSTEM THEN DISCHARGED INTO A INFILTRATION BASIN CONSTRUCTED WITHIN THE PROJECT AREA TO PERCOLATE BACK INTO LOCAL GROUNDWATER. THE BASIN(S) WILL BE CONSTRUCTED WITHIN CLOSE PROXIMITY TO THE EXCAVATIONS AND BE DESIGNED TO PREVENT SPREAD OF CONTAMINATION INTO PREVIOUSLY UNCONTAMINATED MEDIA. THE CONTRACTOR WILL OBTAIN APPROVAL FOR PERCOLATION OF CONTAMINATED GROUNDWATER FROM THE NJDEP VIA AN NJDEP ON-SCENE COORDINATOR DISCHARGE AUTHORITY LETTER. THIS APPROVAL WILL BE ISSUED BASED UPON NJDEP REVIEW AND ACCEPTANCE OF THE CONTRACTOR'S PLAN. AS AN ALTERNATE, EFFLUENT MAY BE DISCHARGED TO THE NORTH HUDSON SEWERAGE AUTHORITY WITH APPROPRIATE PERMITS AND APPROVAL.
- 4. THE CONTRACTOR SHALL MAINTAIN A DAILY LOG DOCUMENTING CONTAMINATED GROUNDWATER AND SURFACE WATER COLLECTION AND HANDLING ACTIVITIES, AND SHALL MAKE THE LOG AVAILABLE TO THE ENGINEER UPON REQUEST. THE LOG SHALL NOTE DAILY WATER REMOVAL, TREATMENT AND DISCHARGE VOLUMES, EFFLUENT SAMPLING ACTIVITIES AND RESULTS (IF REQUIRED), DISCHARGE OR SPILL INCIDENTS, REPORTING ACTIVITIES AND PERTINENT FIELD OBSERVATIONS SUCH AS SHEEN, ODOR, TURBIDITY, AND RUN-ON AND RUN-OFF.
- 5. AN INSPECTION OF THE EXCAVATION SHALL BE MADE BY THE CITY ENGINEER PRIOR TO THE INSTALLATION OF THE DETENTION BASIN.

STRUCTURAL FILL AND BACKFILL

[COORDINATE ALL EARTHWORK WITH GEOTECHNICAL ENGINEERING REPORT]

IMPORT/ON-SITE STRUCTURAL FILL MATERIAL:

SOILS PLACED AS STRUCTURAL FILL MATERIAL SHOULD CONSIST OF WELL GRADED SAND OR GRAVEL WITH A MAXIMUM PARTICLE SIZE OF THREE INCHES IN DIAMETER AND LESS THAN 15 PERCENT OF MATERIAL PASSING THE NUMBER 200 SIEVE. THESE MATERIALS SHOULD BE FREE OF OBJECTIONABLE DEBRIS (CLAY CLUMPS, ORGANIC AND/OR DELETERIOUS MATERIAL, ETC.) AND WITHIN MOISTURE CONTENTS SUITABLE FOR COMPACTION. ALTERNATIVE SOIL TYPES WITH HIGHER PERCENTAGES OF SILT AND CLAY MAY BE CONSIDERED, PROVIDED THAT THE CONTRACTOR IS ABLE TO ACHIEVE PROPER COMPACTION AND MAINTAIN SUITABLE SUBGRADE ONCE THE MATERIAL IS PLACED. FINE-GRAINED SOILS AND/OR GRANULAR SOILS WITH HIGHER PERCENTAGES OF SILT AND CLAY ARE EXTREMELY MOISTURE SENSITIVE AND WILL ONLY BE SUITABLE FOR REUSE AS STRUCTURAL FILL MATERIAL DURING IDEAL WEATHER CONDITIONS. MATERIALS WETTED BEYOND THE OPTIMUM MOISTURE CONTENT; CONTAIN OVERSIZED ROCK OR DEBRIS; AND/OR CONTAIN INCREASED AMOUNTS OF OBJECTIONABLE DEBRIS WILL NOT BE SUITABLE FOR REUSE AS STRUCTURAL FILL MATERIAL WITHOUT SPECIAL HANDLING. AS SUCH, THE CONTRACTOR SHOULD BE RESPONSIBLE FOR IMPORTING STRUCTURAL FILL MATERIAL AND/OR PROCESSING ON-SITE SOILS AS REOUIRED SO THAT THESE MATERIALS ARE SUITABLE FOR STRUCTURAL FILL PLACEMENT.

IF ENCOUNTERED COBBLES/BOULDERS, EXCAVATED ROCK AND/OR OVERSIZED DEBRIS GREATER THAN THREE INCHES IN DIAMETER WILL NEED TO BE SEPARATED FROM ON-SITE SOILS TO BE PLACED AS STRUCTURAL FILL. APPROVED MATERIAL BETWEEN THREE TO 12 INCHES IN DIAMETER MAY BE CRUSHED OR INDIVIDUALLY PLACED IN FILL LAYERS DEEPER THAN TWO FEET BELOW PROPOSED SUBGRADE LEVELS. CARE MUST BE TAKEN TO INDIVIDUALLY SEAT ANY LARGE PARTICLES AND TO COMPACT SOIL AROUND LARGE PARTICLES WITH HAND OPERATED EQUIPMENT TO MINIMIZE THE RISK OF VOID FORMATION. THE LARGER MATERIAL SHOULD NOT BE PLACED NEAR AREAS OF THE PROPOSED UTILITY OR PLANNED EXCAVATION. BOULDERS LARGER THAN APPROXIMATELY 12 INCHES ARE NOT EXPECTED TO BE ADEQUATE FOR USE AS FILL OR BACKFILL AND SHOULD BE REMOVED FROM THE SITE OR CRUSHED TO AN ADEQUATE SIZE.

COMPACTION AND PLACEMENT REQUIREMENTS:

STRUCTURAL FILL AND BACKFILL SHOULD BE PLACED IN MAXIMUM 12 INCH LOOSE LIFTS AND COMPACTED TO 95 PERCENT OF THE MAXIMUM DRY DENSITY WITHIN A TARGETED TWO PERCENT OF THE OPTIMUM MOISTURE CONTENT AS DETERMINED BY ASTM D 1557 (MODIFIED PROCTOR). FILL MATERIAL COMPACTED WITH RELATIVELY LIGHT HAND HELD EQUIPMENT MAY NEED TO BE PLACED IN THINNER LIFTS.

STRUCTURAL FILL TESTING:


BEFORE FILLING OPERATIONS BEGIN, REPRESENTATIVE SAMPLES OF EACH PROPOSED FILL MATERIAL (ON-SITE AND IMPORTED) SHOULD BE COLLECTED. THE SAMPLES SHOULD BE TESTED TO DETERMINE THE MAXIMUM DRY DENSITY, OPTIMUM MOISTURE CONTENT, NATURAL MOISTURE CONTENT, GRADATION, AND PLASTICITY OF THE SOIL. THESE TESTS ARE NEEDED FOR QUALITY CONTROL DURING COMPACTION AND ALSO TO DETERMINE IF THE FILL MATERIAL IS ACCEPTABLE. THE PLACEMENT OF ALL FILL AND BACKFILL SHOULD BE MONITORED BY A GEOTECHNICAL ENGINEER OR TECHNICIAN TO ENSURE THAT THE SPECIFIED MATERIAL AND LIFT THICKNESSES ARE PROPERLY INSTALLED. A SUFFICIENT NUMBER OF IN-PLACE DENSITY TESTS SHOULD BE PERFORMED DURING FILL PLACEMENT TO ENSURE THAT THE SPECIFIED COMPACTION IS ACHIEVED THROUGHOUT THE HEIGHT OF THE FILL OR BACKFILL.


NATIONAL PARK SERVICE TOPSOIL AND IMPORTED FILL REQUIREMENTS:

INTACT NATIVE TOPSOIL FROM THE PROJECT AREA SHALL BE RETAINED WHENEVER FEASIBLE. SHOULD ADDITIONAL FILL BE NEEDED, ALL FILL MUST BE OF QUALITY SUITABLE FOR USE IN A NATIONAL PARK UNIT. AT SHAO, THIS IS TYPICALLY NJ RESIDENTIAL DIRECT CONTACT STANDARDS, UNLESS OTHERWISE APPROVED IN ADVANCE BY NPS. THOSE STANDARDS DO NOT INCLUDE RADIONUCLIDES. ANY SUBSTRUCTURE FILL SHOULD BE TESTED/INSPECTED TO ENSURE RADIONUCLIDES ARE NOT PRESENT IN A CONCENTRATION THAT DECAY WILL RESULT IN RELEASE OF RADON GAS IN A CONCENTRATION THAT WOULD BE A HEALTH CONCERN. ANY FILL MATERIALS REQUIRED FOR THE PROJECT MUST BE OBTAINED FROM A PARK-APPROVED SOURCE.

200' PROPERTY OWNER'S LIST

BLOCK	LOT	OWNER	OWNER ADDRESS	ADDRESS OF PROPERTY WITHIN 200 FEET			
135.0	1	Christina J. Spadavecchia	104 Whispering Hills Dr. South Plainfield, NJ 07080	76 Washington Avenue, North Plainfield, NJ 07060			
135.0	2	Marcia Wiggan	78 Washington Avenue, North Plainfield, NJ 07060	78 Washington Avenue, North Plainfield, NJ 07060			
135.0	3	Luis Garces	80 Washington Avenue, North Plainfield, NJ 07060	80 Washington Avenue, North Plainfield, NJ 07060			
135.0	4	Steven & Elana Tobengauz	4 Wagon Way, Holmdel, NJ 07733	11 Rockview Avenue, North Plainfield, NJ 07060			
135.0	11	Thomas & Nancy Young	138 Rockaway Road, Lebanon, NJ 08833	82 Linden Avenue, North Plainfield, NJ 07060			
136.0	1	Arutro & Andrea Torres	2323 Park Avenue South Plainfield, NJ 07080	144-148 Sycamore Avenue, North Plainfield, NJ 07060			
136.0	2	Jose, Veronica & Nezo Velazquez	154 Sycamore Avenue, North Plainfield, NJ 07060	154 Sycamore Avenue, North Plainfield, NJ 07060			
136.0	3	Milton & Garces Villabreses	154-156 Sycamore Avenue, North Plainfield, NJ 07060	154-156 Sycamore Avenue, North Plainfield, NJ 07060			
136.0	4	Jorge Salguero	103 Linden Avenue, North Plainfield, NJ 07060	103 Linden Avenue, North Plainfield, NJ 07060			
136.0	5	Stanley Goodwin	P.O. Box 2 Raritan, NJ 08869	99 Linden Avenue, North Plainfield, NJ 07060			
136.0	6	Kateryn & Alfredo Pequero	2438 Morris Avenue, Apt 5A, Bronx, NY 10468	73 Washington Avenue, North Plainfield, NJ 07060			
136.0	7	Khaled, Ismail & Christina Kwok	69 Washington Avenue, North Plainfield, NJ 07060	69 Washington Avenue, North Plainfield, NJ 07060			
136.0	8	Marcia Santana	65 Washington Avenue, North Plainfield, NJ 07060	65 Washington Avenue, North Plainfield, NJ 07060			
136.0	9	Andy Pierre & Edele St Jean	106 Park Place, North Plainfield, NJ 07060	106 Park Place, North Plainfield, NJ 07060			
136.0	10	Francisco Aguilar	110-112 Park Place, North Plainfield, NJ 07060	110-112 Park Place, North Plainfield, NJ 07060			
131.0	26	Elizabeth Beebe	12 Rockview Avenue, North Plainfield, NJ 07060	12 Rockview Avenue, North Plainfield, NJ 07060			
131.0	27	Steven & Judtih Romeo	16 Rockview Avenue, North Plainfield, NJ 07060	16 Rockview Avenue, North Plainfield, NJ 07060			
131.0	28	Stephen & Marie Colangelo	249 Railroad Avenue, Stirling, NJ 07980	18-20 Rockview Avenue, North Plainfield, NJ 07060			
131.0	29	Yeshive Tiferes Boruch, Inc.	112 Linden Avenue, North Plainfield, NJ 07060	22-24 Rockview Avenue, North Plainfield, NJ 07060			
131.0	30	Yeshive Tiferes Boruch, Inc.	21 Rockview Avenue, North Plainfield, NJ 07060	26-28 Rockview Avenue, North Plainfield, NJ 07060			
131.0	31.01	Yeshive Tiferes Boruch, Inc.	21 Rockview Avenue, North Plainfield, NJ 07060	30 Rockview Avenue, North Plainfield, NJ 07060			
131.0	31.02	Yeshive Tiferes Boruch, Inc.	21 Rockview Avenue, North Plainfield, NJ 07060	32 Rockview Avenue, North Plainfield, NJ 07060			
131.0	32	Anthony Baker	34 Rockview Avenue, North Plainfield, NJ 07060	34 Rockview Avenue, North Plainfield, NJ 07060			
132.0	1	Reid Kirchberger	171 Sycamore Avenue, North Plainfield, NJ 07060	171 Sycamore Avenue, North Plainfield, NJ 07060			
132.0	2	Eva Marie Mondovano	167 Sycamore Avenue, North Plainfield, NJ 07060	167 Sycamore Avenue, North Plainfield, NJ 07060			
132.0	3	Allen & Sora Uhr	163 Sycamore Avenue, North Plainfield, NJ 07060	163 Sycamore Avenue, North Plainfield, NJ 07060			
132.0	4	Tsvi Chaim & Tzivia Blumenfeld	159 Sycamore Avenue, North Plainfield, NJ 07060	159 Sycamore Avenue, North Plainfield, NJ 07060			
132.0	5	John Price	153 Sycamore Avenue, North Plainfield, NJ 07060	153 Sycamore Avenue, North Plainfield, NJ 07060			
132.0	6	149 Sycamore Ave Realty, LLC	20 Roberts Road, Warren, NJ 07059	145-151 Sycamore Avenue, North Plainfield, NJ 07060			
132.0	20	Devon Sobers	35 Rockview Avenue, North Plainfield, NJ 07060	35 Rockview Avenue, North Plainfield, NJ 07060			
132.0	21.01	Rockview Property Investment, LLC	77 Briarwood Drive, West Warren, NJ 07059	29-33 Rockview Avenue, North Plainfield, NJ 07060			
132.0	21.02	Theodore & Theo Slack	10 Northridge Way, Warren, NJ 07059	175 Sycamore Avenue, North Plainfield, NJ 07060			
137.0	3	74 Washington, LLC	70-74 Washington Avenue, North Plainfield, NJ 07060	70-74 Washington Avenue, North Plainfield, NJ 07060			

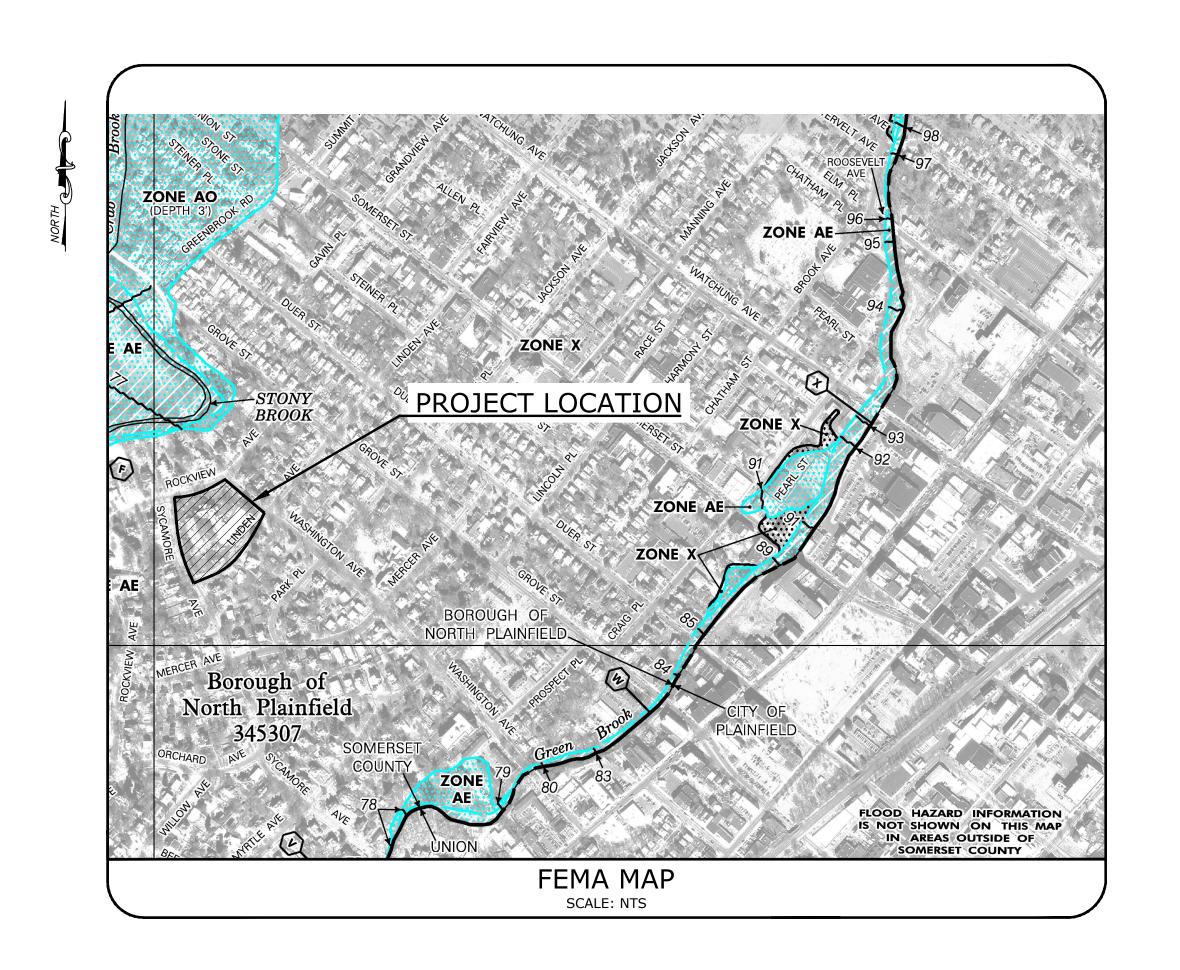

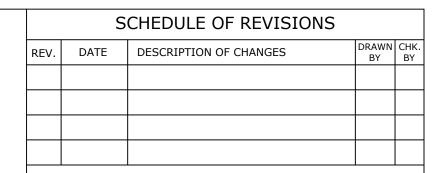

OWNER/APPLICANT
YESHIVA TIFERES BORUCH, INC.
112 LINDEN AVENUE
NORTH PLAINFIELD, NJ 07060

E 2 PROJECT MANAGEMENT LLC

87 HIBERNIA AVENUE ROCKAWAY, N.J. 07866 PHONE: (973) 299-5200 FAX: (973) 299-5059 www.E2PM.com

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N.J. ENGINEERING CERTIFICATE OF AUTHORIZATION No. 24GA28118200

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CHARLES J. STEWART, P.E., P.L.S. N.J. NO. 24GB03588400 REGISTERED PROFESSIONAL ENGINEER AND LAND SURVEYOR

PROJECT NAME

YESHIVA NEW ACADEMY BUILDING

TAX LOT 1 BLOCK 134


21 ROCKVIEW AVENUE BOROUGH OF NORTH PLAINFIELD SOMERSET COUNTY, NJ

DRAWING TITLE

GENERAL NOTES AND 200' PROPERTY OWNER'S LIST

CHECKED BY:	CS	DRAWN BY: ENS
SCALE:	AS NOTED	SHEET NO: 2 OF 15
PROJECT #: P-2	2-47-01	FIRST ISSUE: 8/24/2022

SP-101.00

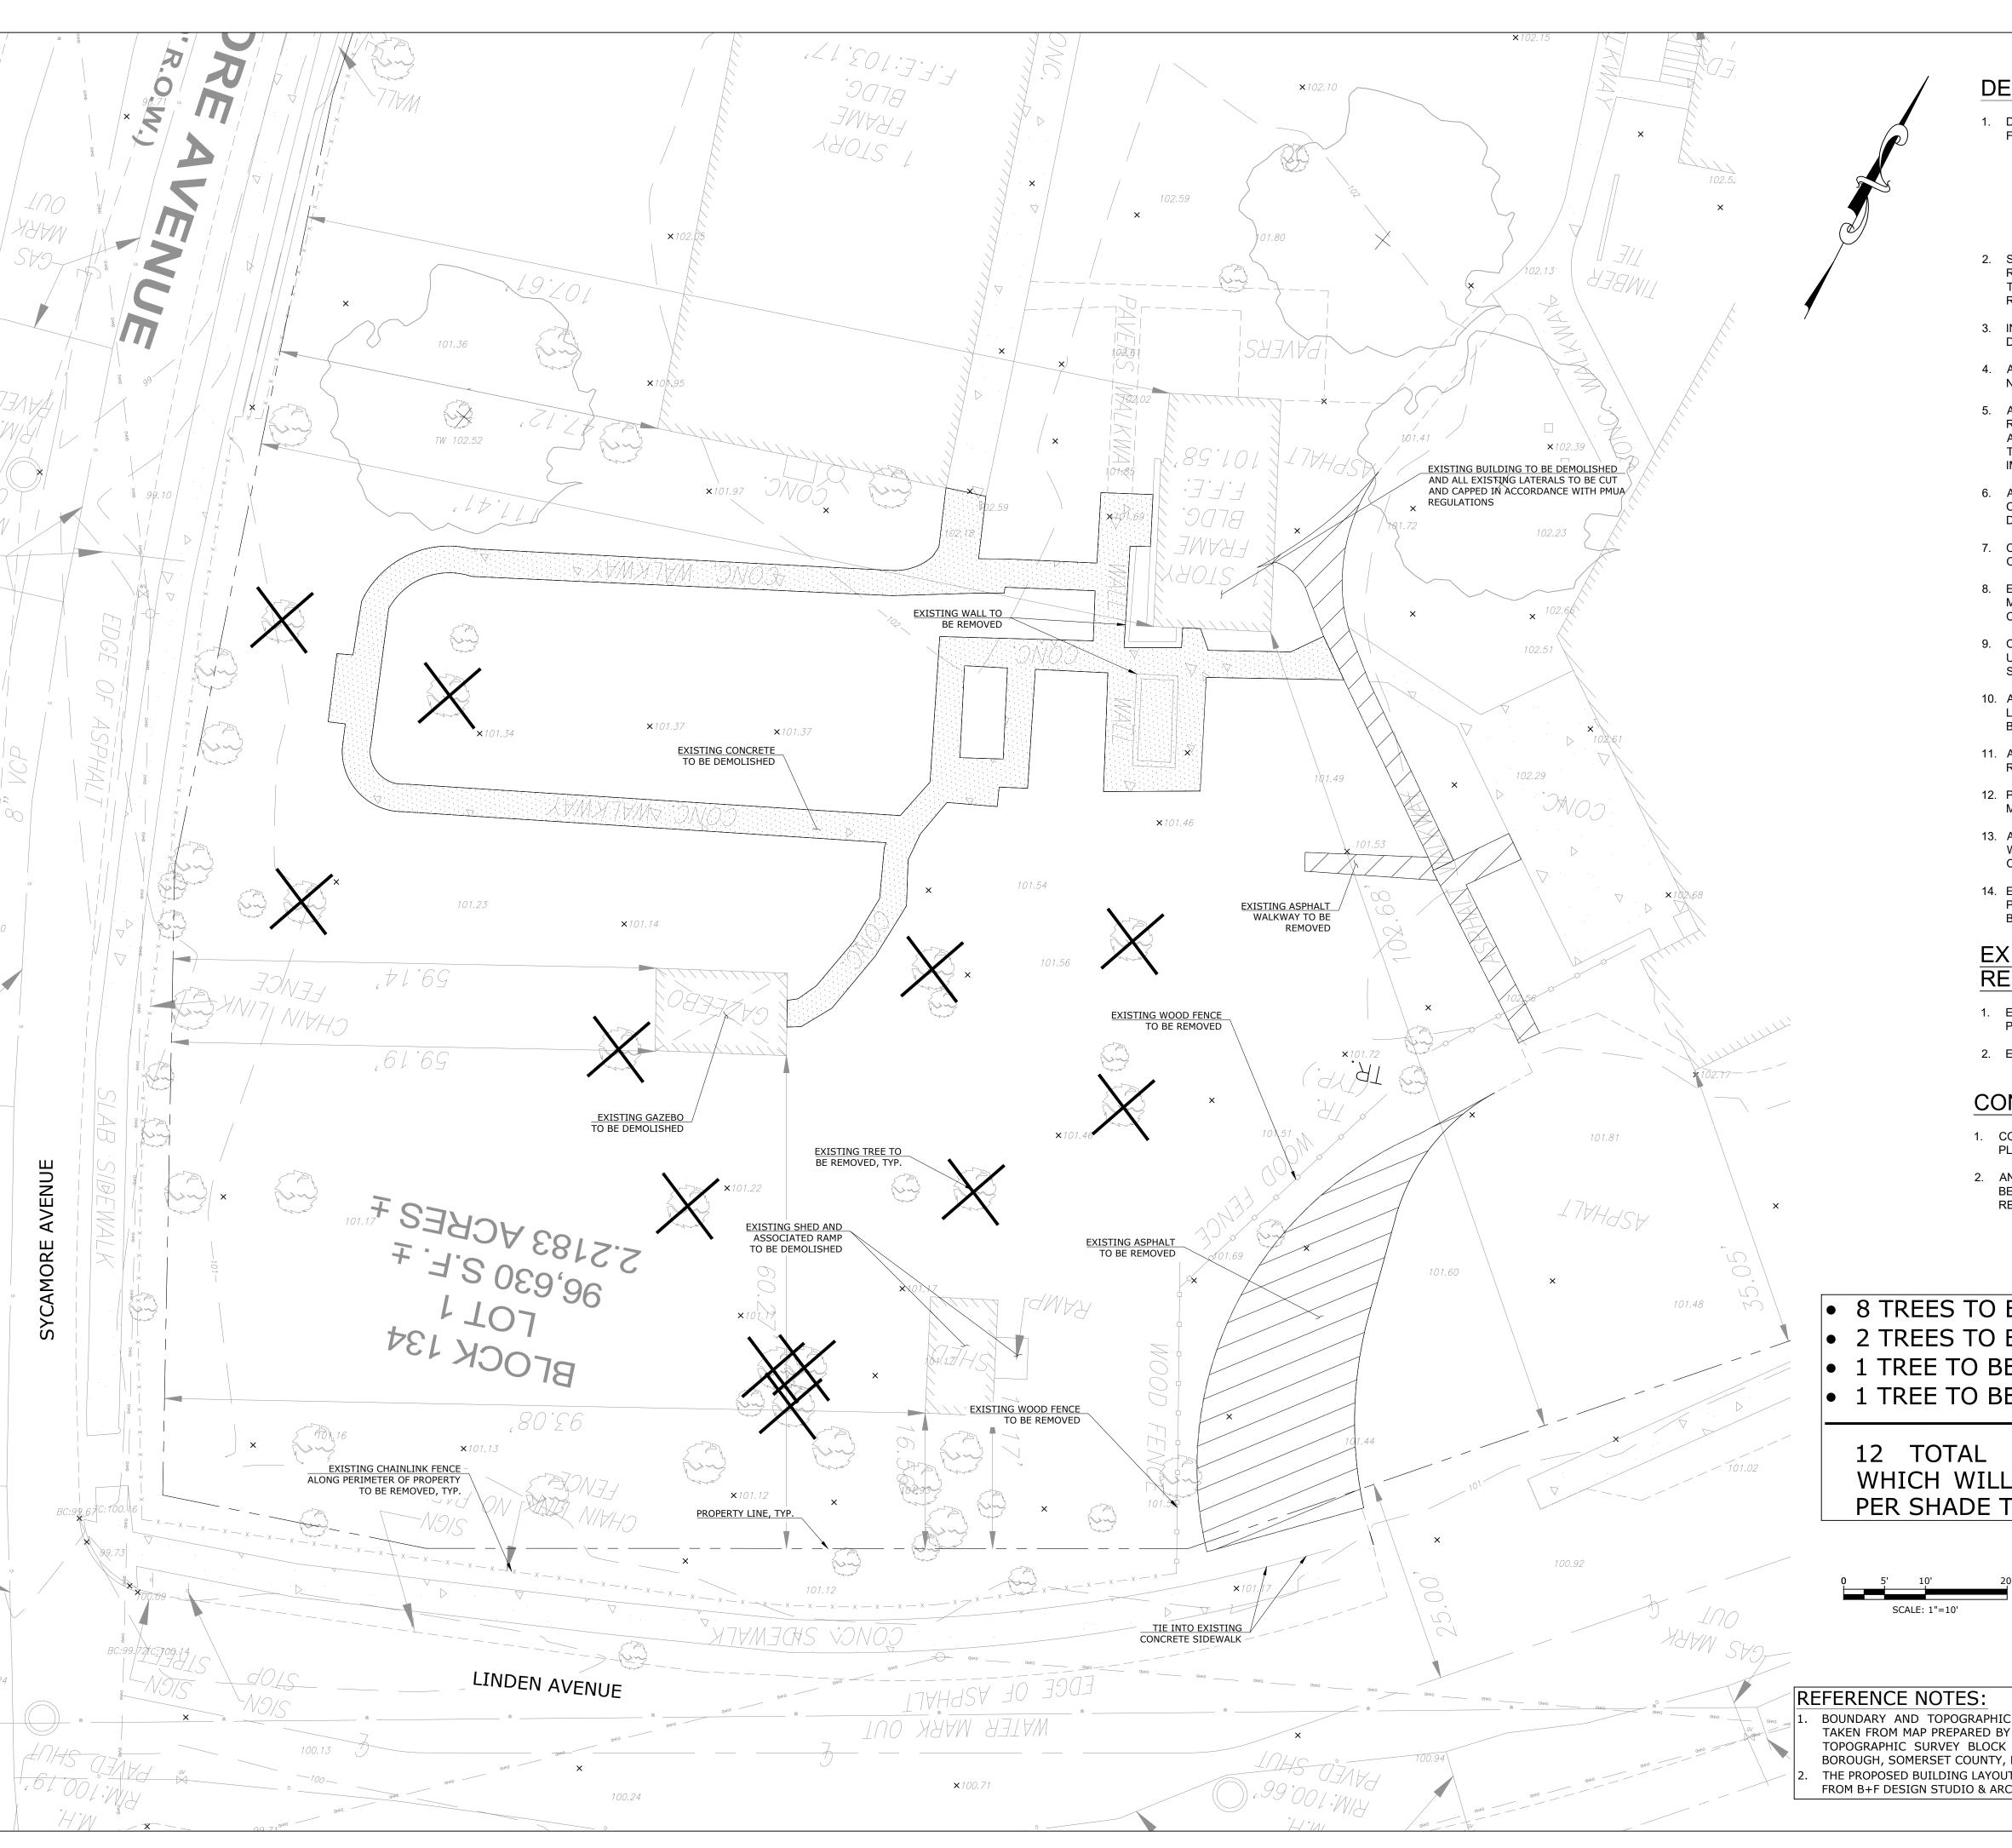

DEMOLITION NOTES

- DURING SITE DEMOLITION AND REPAIRS, THE FOLLOWING FEATURES SHALL REMAIN UNLESS SPECIFIED:
 - EXISTING CURBS
 - EXISTING SIDEWALKS
 - EXISTING TREES (SIDEWALK) EXISTING LIGHT POLES WITHIN R.O.W.
 - EXISTING UTILITY POLES WITHIN R.O.W. EXISTING UNDERGROUND UTILITIES
 - EXISTING STREET SIGNS
- SURVEY EXISTING BUILDINGS FOR HAZARDOUS WASTE. REMOVE ALL HAZARDOUS WASTE AND SOLID WASTE PRIOR TO DEMOLITION PER STATE AND FEDERAL RULES AND REGULATIONS.
- 3. INSTALL ANTI-VERMIN MEASURES 30 DAYS PRIOR TO DEMOLITION.
- 4. ALL EXISTING ADA RAMPS AT EACH STREET CORNER SHALL NOT BE DEMOLISHED.
- 5. ALL EXISTING U/G UTILITIES ENTERING THE SITE SHALL BE RE-LOCATED OR REMOVED IN ACCORDANCE WITH APPLICABLE REGULATIONS PRIOR TO ANY DEMOLITION IF THEY CONFLICT WITH ANY OF THE PROPOSED IMPROVEMENTS.
- 6. ALL EXISTING MANHOLES, VALVE BOXES, UTILITY ACCESS, CATCH BASINS ETC. SHALL BE PROTECTED AND NOT DAMAGED. RESET THE TOP OF RIMS AS NOTED ON PLANS.
- 7. CATCH BASINS AND MANHOLES SHOWN SHALL BE CLEANED OUT AS DIRECTED.
- 8. EXISTING FIRE HYDRANTS SHALL BE PROTECTED AND MAINTAINED ACTIVE THROUGHOUT THE DEMOLITION AND CONSTRUCTION OF THE PROJECT.
- 9. CONTRACTOR SHALL BE RESPONSIBLE FOR REMOVING ALL U/G OBSTRUCTIONS AND DISPOSING OF ALL EXCAVATED SOILS AND SPOILS.
- 10. ALL DAMAGED PUBLIC PROPERTY, INCLUDING BUT NOT LIMITED TO, CURBING, LIGHT POLES, LANDSCAPING, ETC. TO BE PROTECTED DURING DEMOLITION AND CONSTRUCTION.
- 11. ANY DAMAGE TO THE PUBLIC RIGHT OF WAY MUST BE REPAIRED/INSTALLED TO EQUAL STANDARDS.
- 12. PEDESTRIAN ACCESS ALONG PUBLIC STREETS TO BE MAINTAINED AT ALL TIMES.
- 13. APPLICANT AND PLANNING DIVISION SHALL COORDINATE WITH PSEG FOR THE REMOVAL OF FLOODLIGHTS MOUNTED ON TWO (2) UTILITY POLES ON WEST THIRD STREET.
- 14. EXISTING LATERALS SHALL BE CAPPED AND ABANDONED IN PLACE PER PMUA REGULATIONS. LATERAL CAPPING MUST BE OBSESSED BY PMUA STAFF.

EXISTING TREE PROTECTION & REMOVAL NOTES

- 1. EXISTING TREES THAT ARE TO REMAIN SHALL BE PROTECTED WITH TREE FENCING INSTALLED PER DETAIL.
- 2. EXISTING TREES SHALL BE TRIMMED BACK AS NEEDED.

CONSTRUCTION SAFETY

- CONTRACTOR SHALL IMPLEMENT A SIDEWALK PROTECTION PLAN TO SAFEGUARD THE PEDESTRIANS.
- 2. ANY SIDEWALK CLOSURES DURING CONSTRUCTION SHALL BE COORDINATED WITH THE CITY, COUNTY AND STATE AS
- 8 TREES TO BE REMOVED 4"-8" DBH
- 2 TREES TO BE REMOVED 12"-18" DBH
- 1 TREE TO BE REMOVED 18"-24" DBH
- 1 TREE TO BE REMOVED 24"36" DBH

12 TOTAL TREES TO BE REMOVED WHICH WILL REQUIRED 23 NEW TREES PER SHADE TREE ORDINANCE

TOPOGRAPHIC SURVEY BLOCK 134 - LOT 1, 21 ROCKVIEW AVENUE, NORTH PLAINFIELD BOROUGH, SOMERSET COUNTY, NEW JERSEY" DATED DECEMBER 6, 2021.

THE PROPOSED BUILDING LAYOUT BASED ON ARCHITECTURAL PLANS PROVIDED ELECTRONICALLY FROM B+F DESIGN STUDIO & ARCHITECTURAL SERVICES ON AUGUST 17, 2022.

	S	CHEDULE OF REVISIONS		
/.	DATE	DESCRIPTION OF CHANGES	DRAWN BY	CHK. BY

OWNER/APPLICANT YESHIVA TIFERES BORUCH, INC. 112 LINDEN AVENUE NORTH PLAINFIELD, NJ 07060

E 2 PROJECT MANAGEMENT LLC

87 HIBERNIA AVENUE ROCKAWAY, N.J. 07866 PHONE: (973) 299-5200 www.E2PM.com

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N.J. ENGINEERING CERTIFICATE OF AUTHORIZATION No. 24GA28118200

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YESHIVA NEW ACADEMY BUILDING

TAX LOT 1 BLOCK 134


21 ROCKVIEW AVENUE BOROUGH OF NORTH PLAINFIELD SOMERSET COUNTY, NJ


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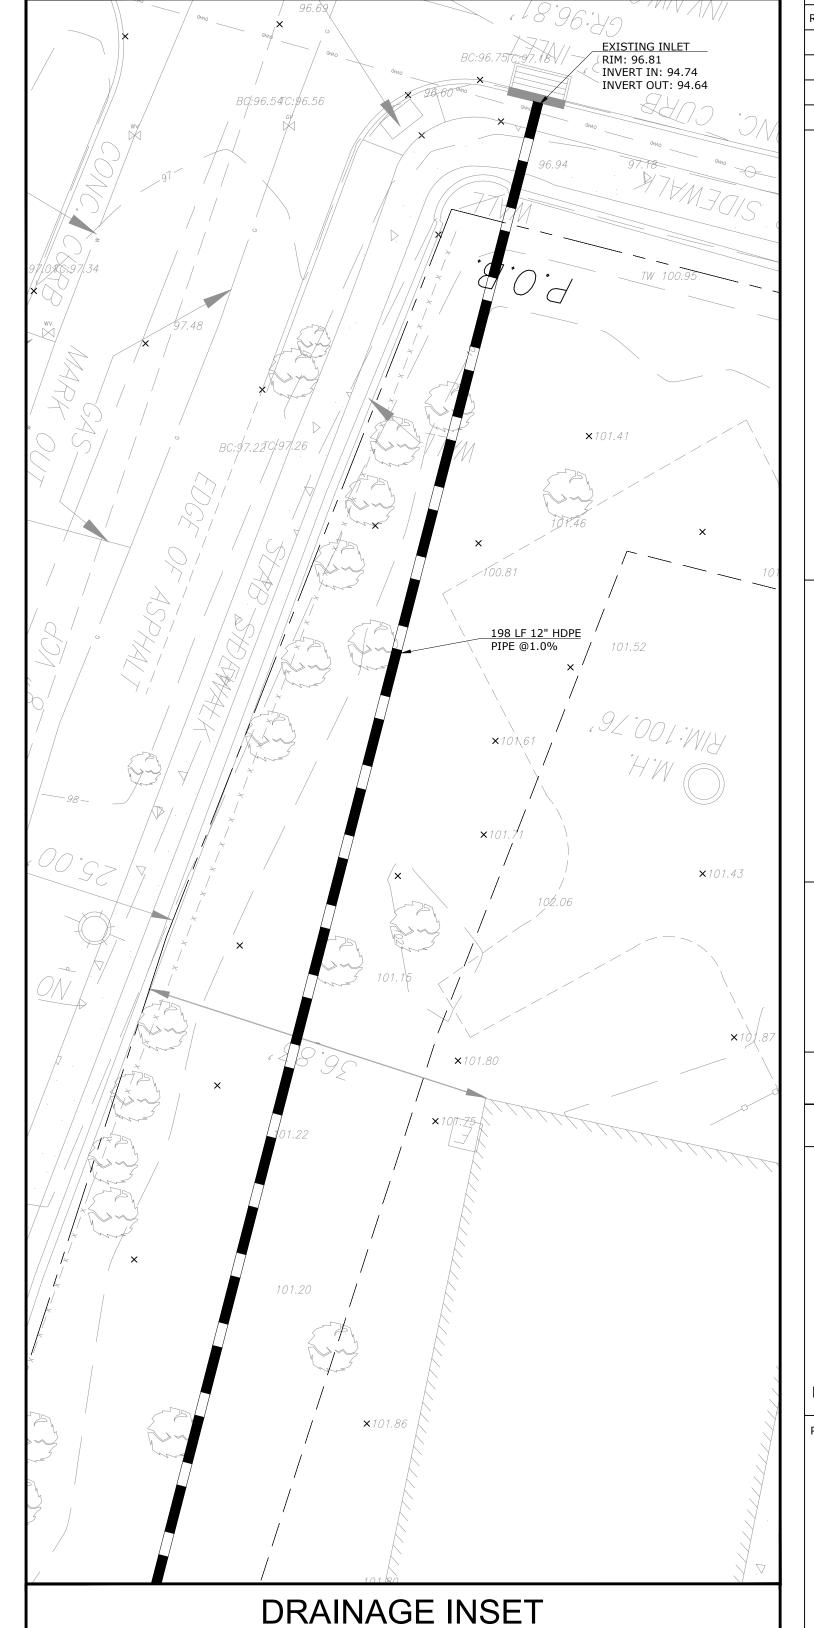
EXISTING CONDITION AND DEMOLITION PLAN

	CHECKED BY:	CS	DRAWN BY: ENS	
	SCALE:	1" = 10'	SHEET NO: 3 OF 15	
	PROJECT #: P-2	22-47-01	FIRST ISSUE: 8/24/2	022
ı	DD 411/71/0 1/0			

SP-102.00




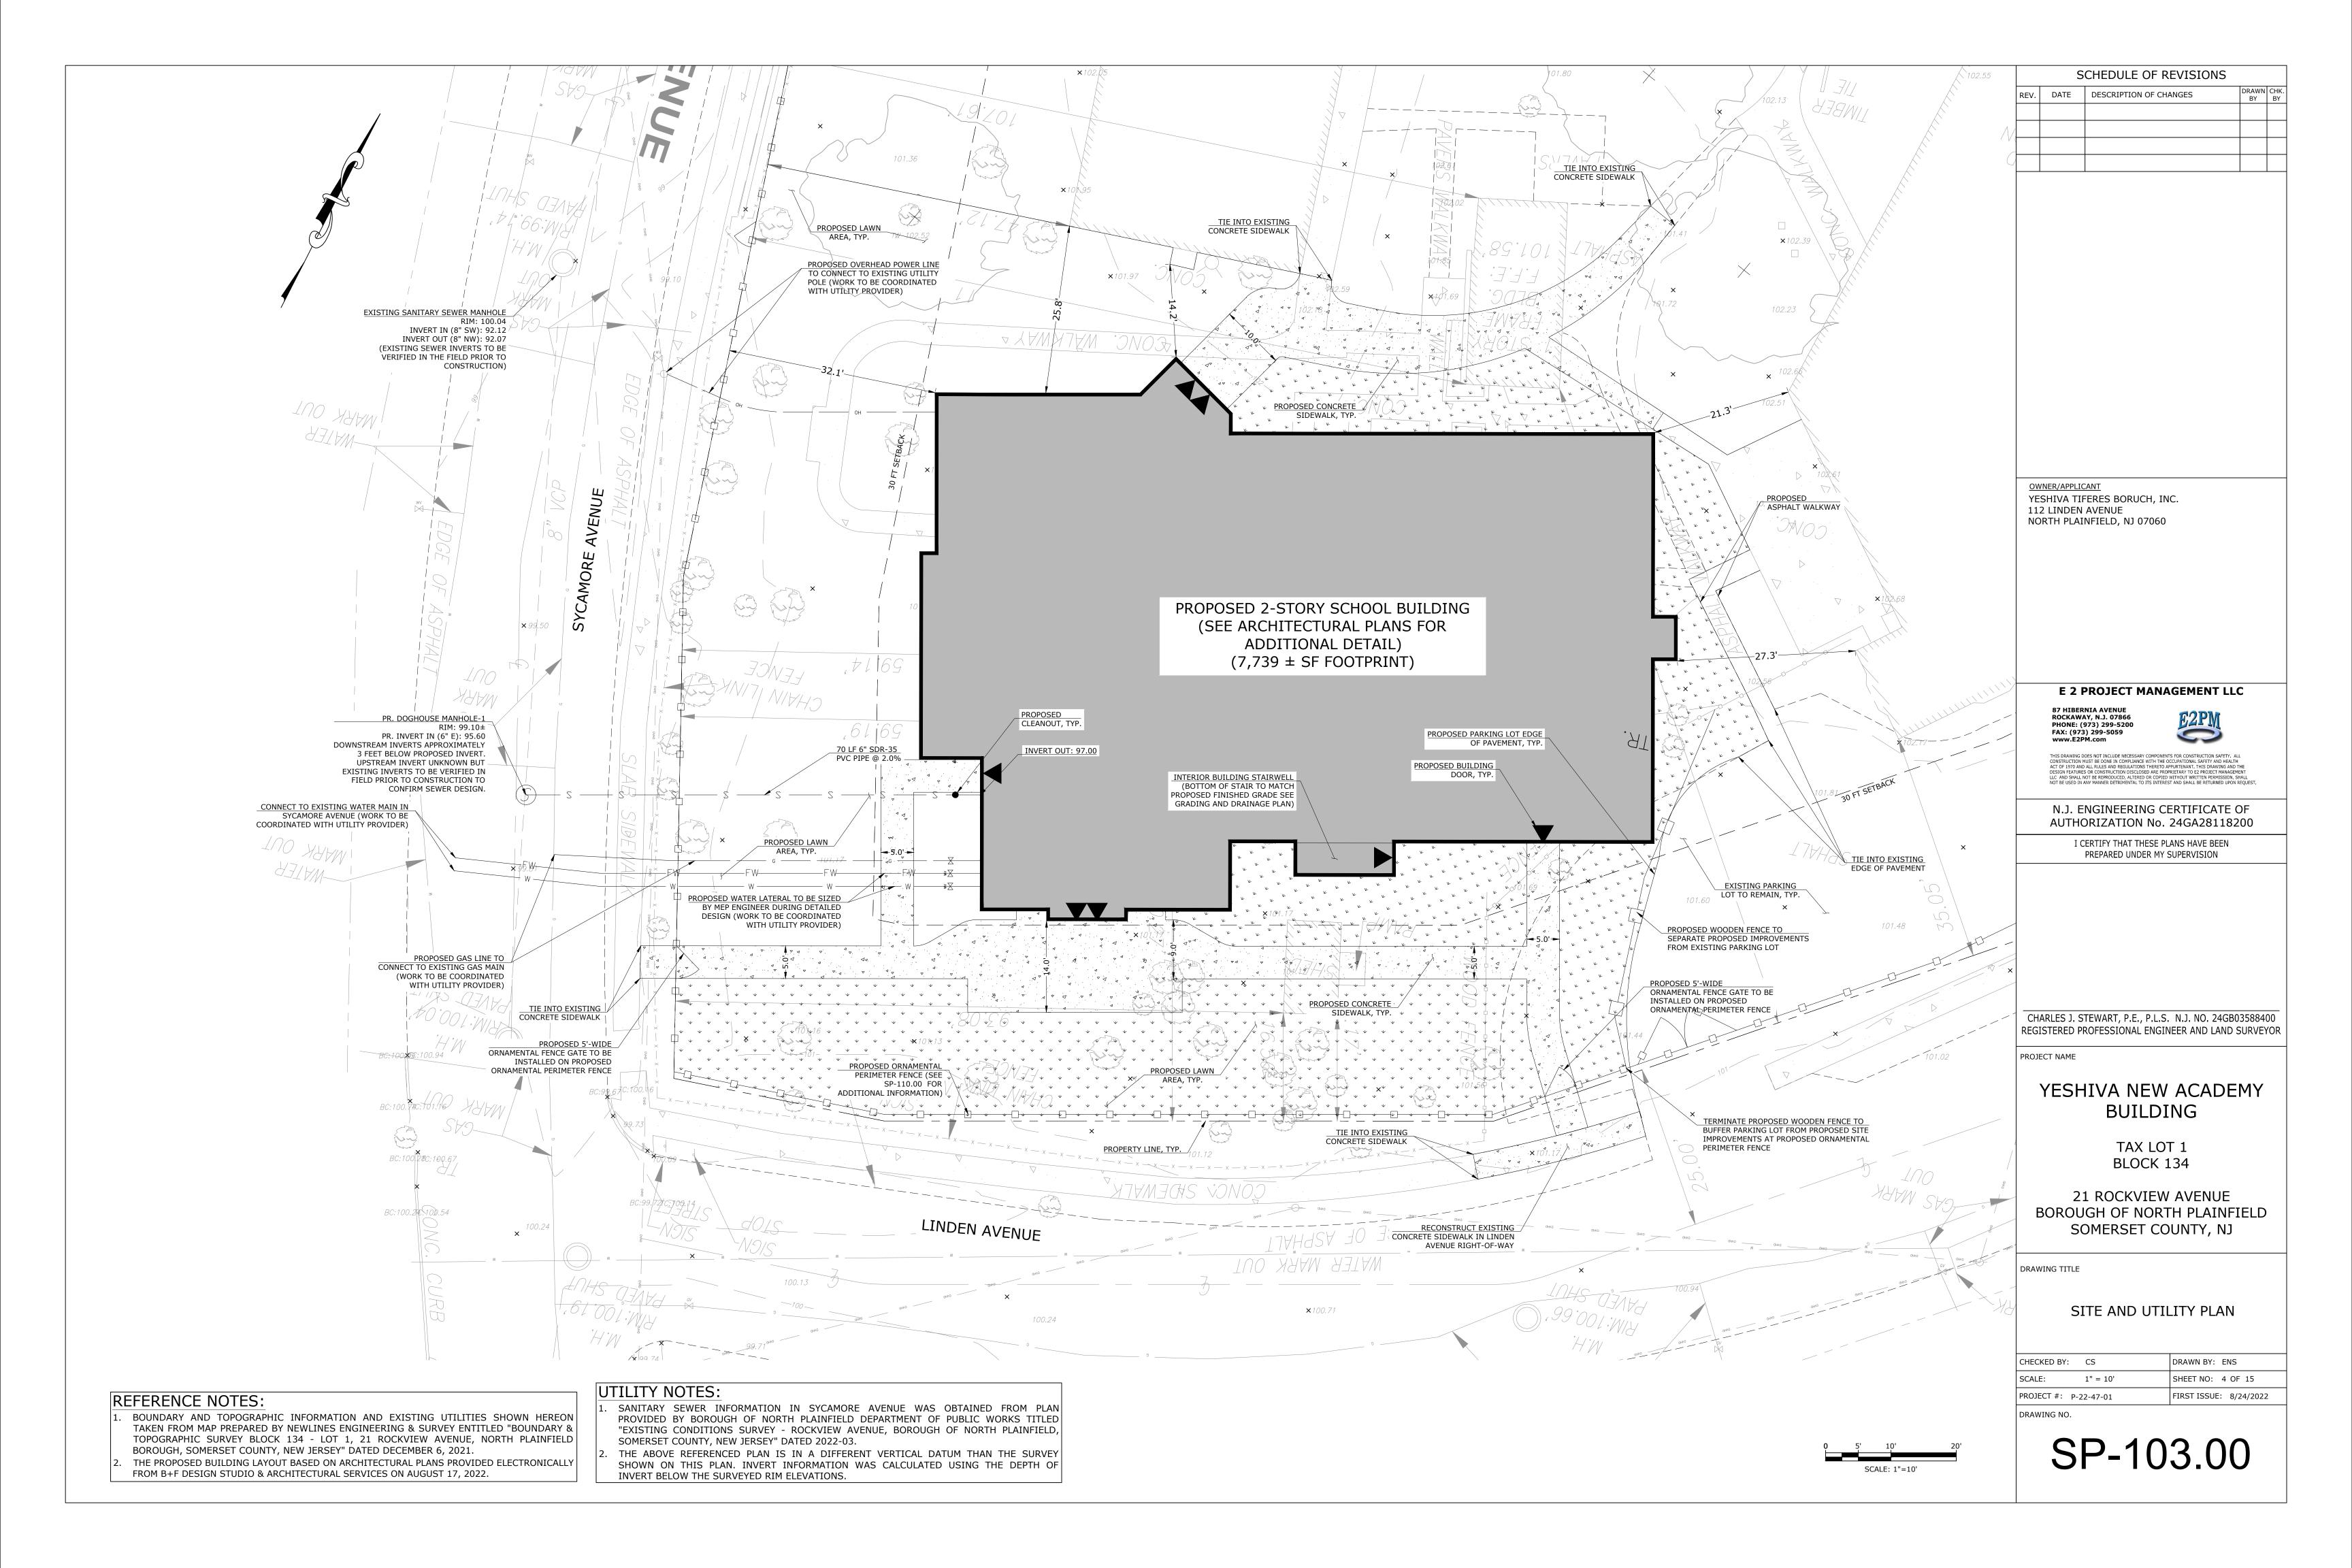

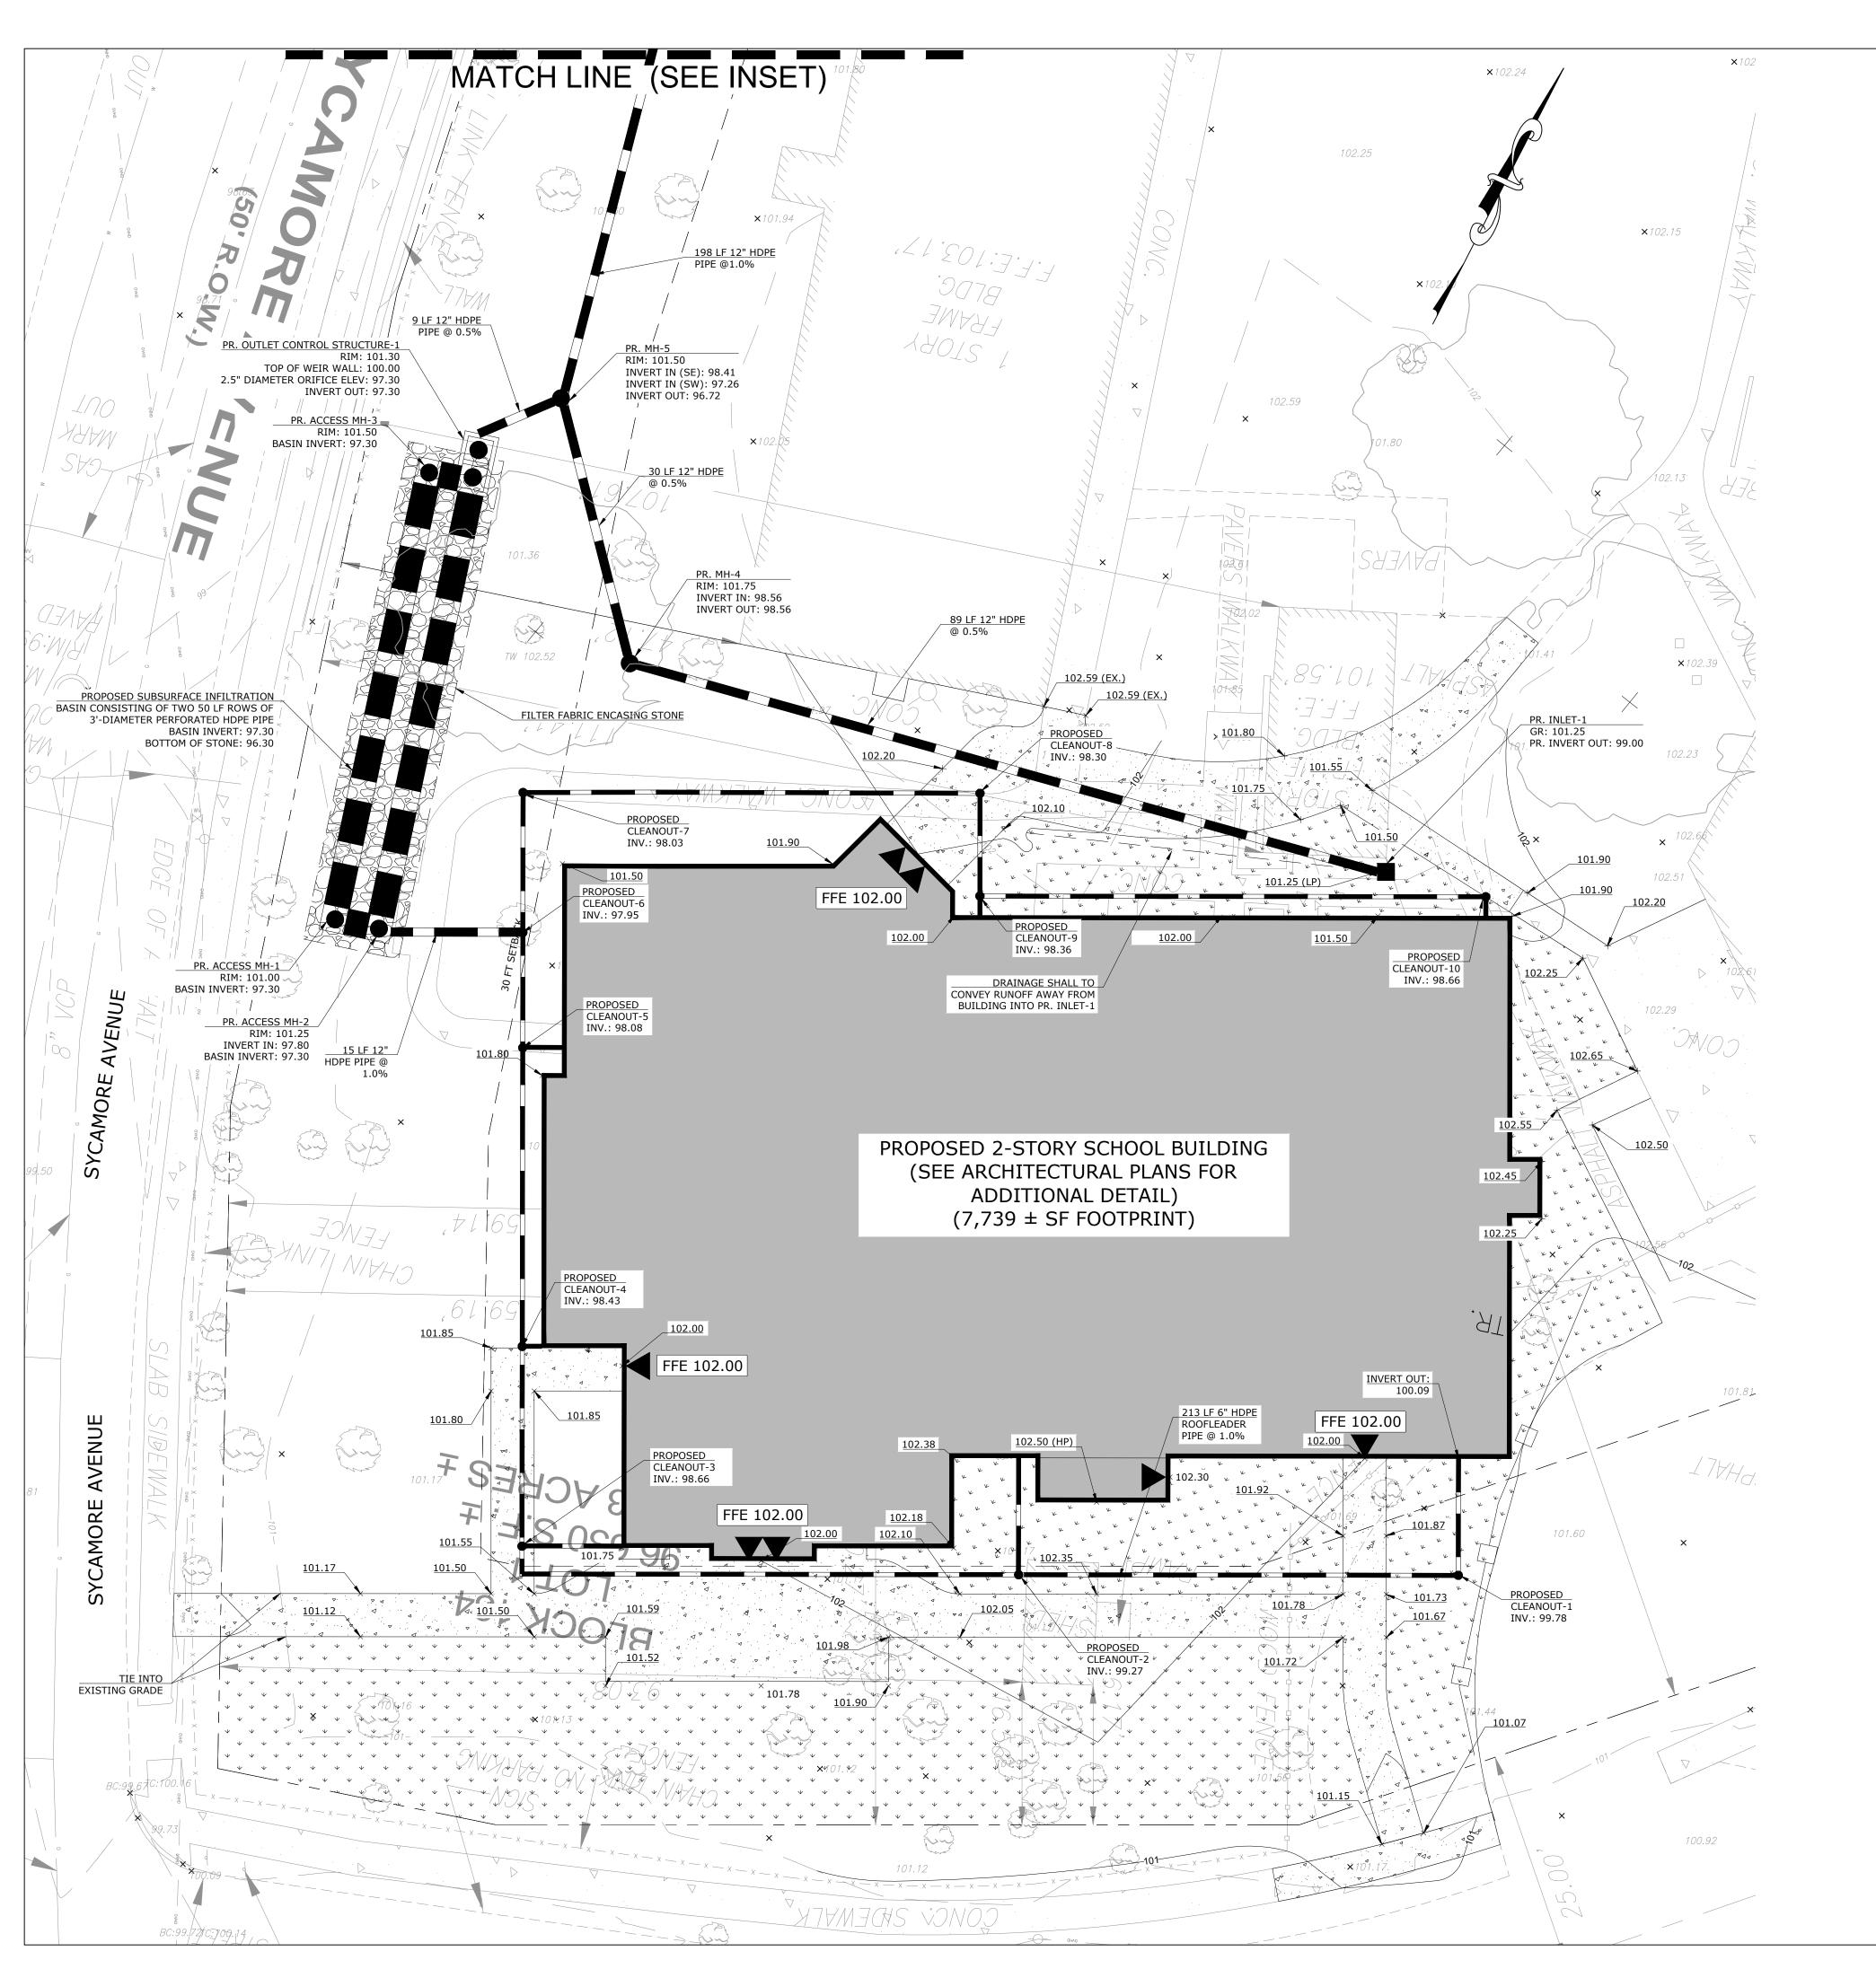

REFERENCE NOTES:

- 1. BOUNDARY AND TOPOGRAPHIC INFORMATION AND EXISTING UTILITIES SHOWN HEREON TAKEN FROM MAP PREPARED BY NEWLINES ENGINEERING & SURVEY ENTITLED "BOUNDARY & TOPOGRAPHIC SURVEY BLOCK 134 LOT 1, 21 ROCKVIEW AVENUE, NORTH PLAINFIELD BOROUGH, SOMERSET COUNTY, NEW JERSEY" DATED DECEMBER 6, 2021.
- 2. THE PROPOSED BUILDING LAYOUT BASED ON ARCHITECTURAL PLANS PROVIDED ELECTRONICALLY FROM B+F DESIGN STUDIO & ARCHITECTURAL SERVICES ON AUGUST 17, 2022.

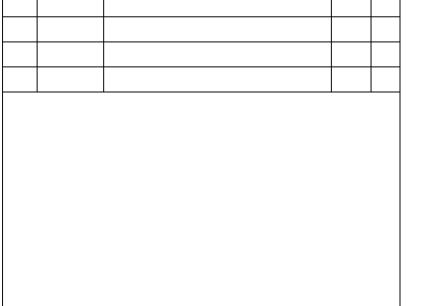

SCHEDULE OF REVISIONS

DATE DESCRIPTION OF CHANGES

OWNER/APPLICANT
YESHIVA TIFERES BORUCH, INC.
112 LINDEN AVENUE
NORTH PLAINFIELD, NJ 07060

E 2 PROJECT MANAGEMENT LLC

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OJECT NAME

YESHIVA NEW ACADEMY BUILDING

TAX LOT 1 BLOCK 134

21 ROCKVIEW AVENUE BOROUGH OF NORTH PLAINFIELD SOMERSET COUNTY, NJ


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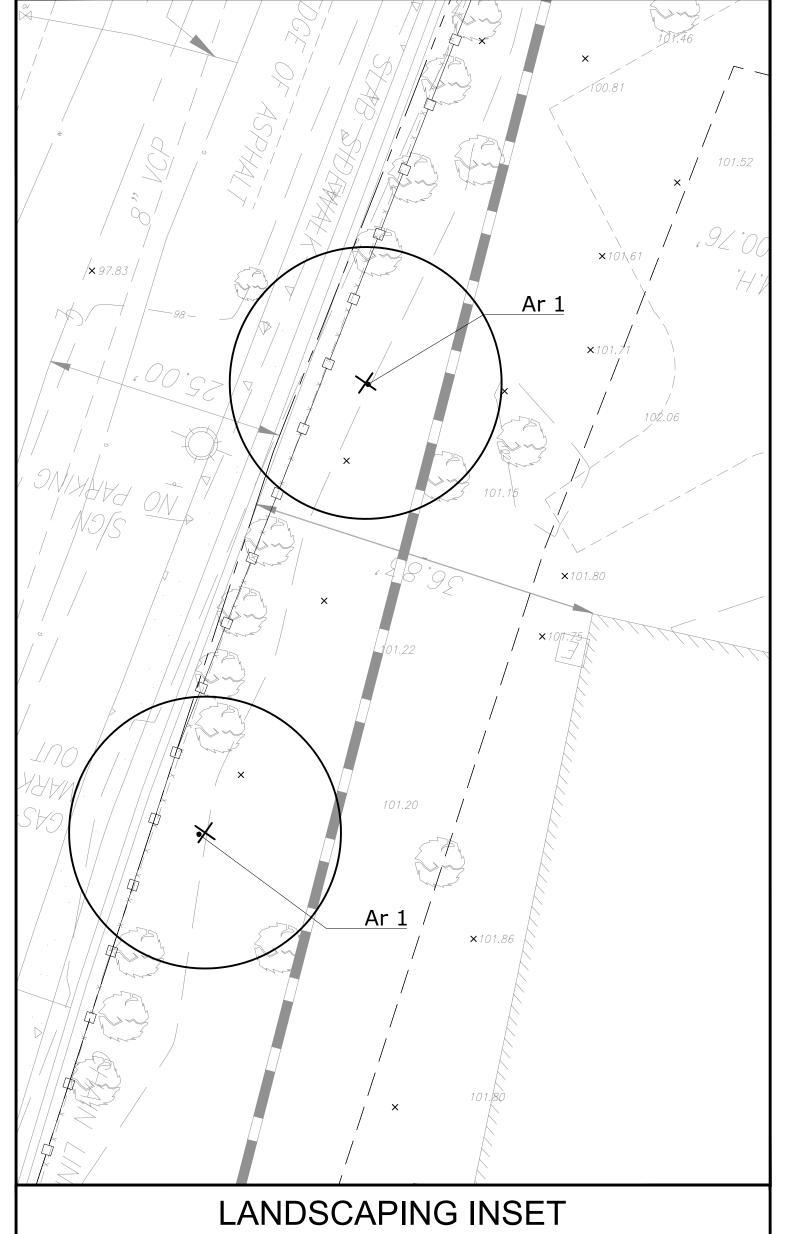
GRADING AND DRAINAGE PLAN

CHECKED BY: CS	DRAWN BY: ENS
SCALE: 1" = 10'	SHEET NO: 5 OF 15
PROJECT #: P-22-47-01	FIRST ISSUE: 8/24/2022
DD ANATALO NIO	



SP-104.00



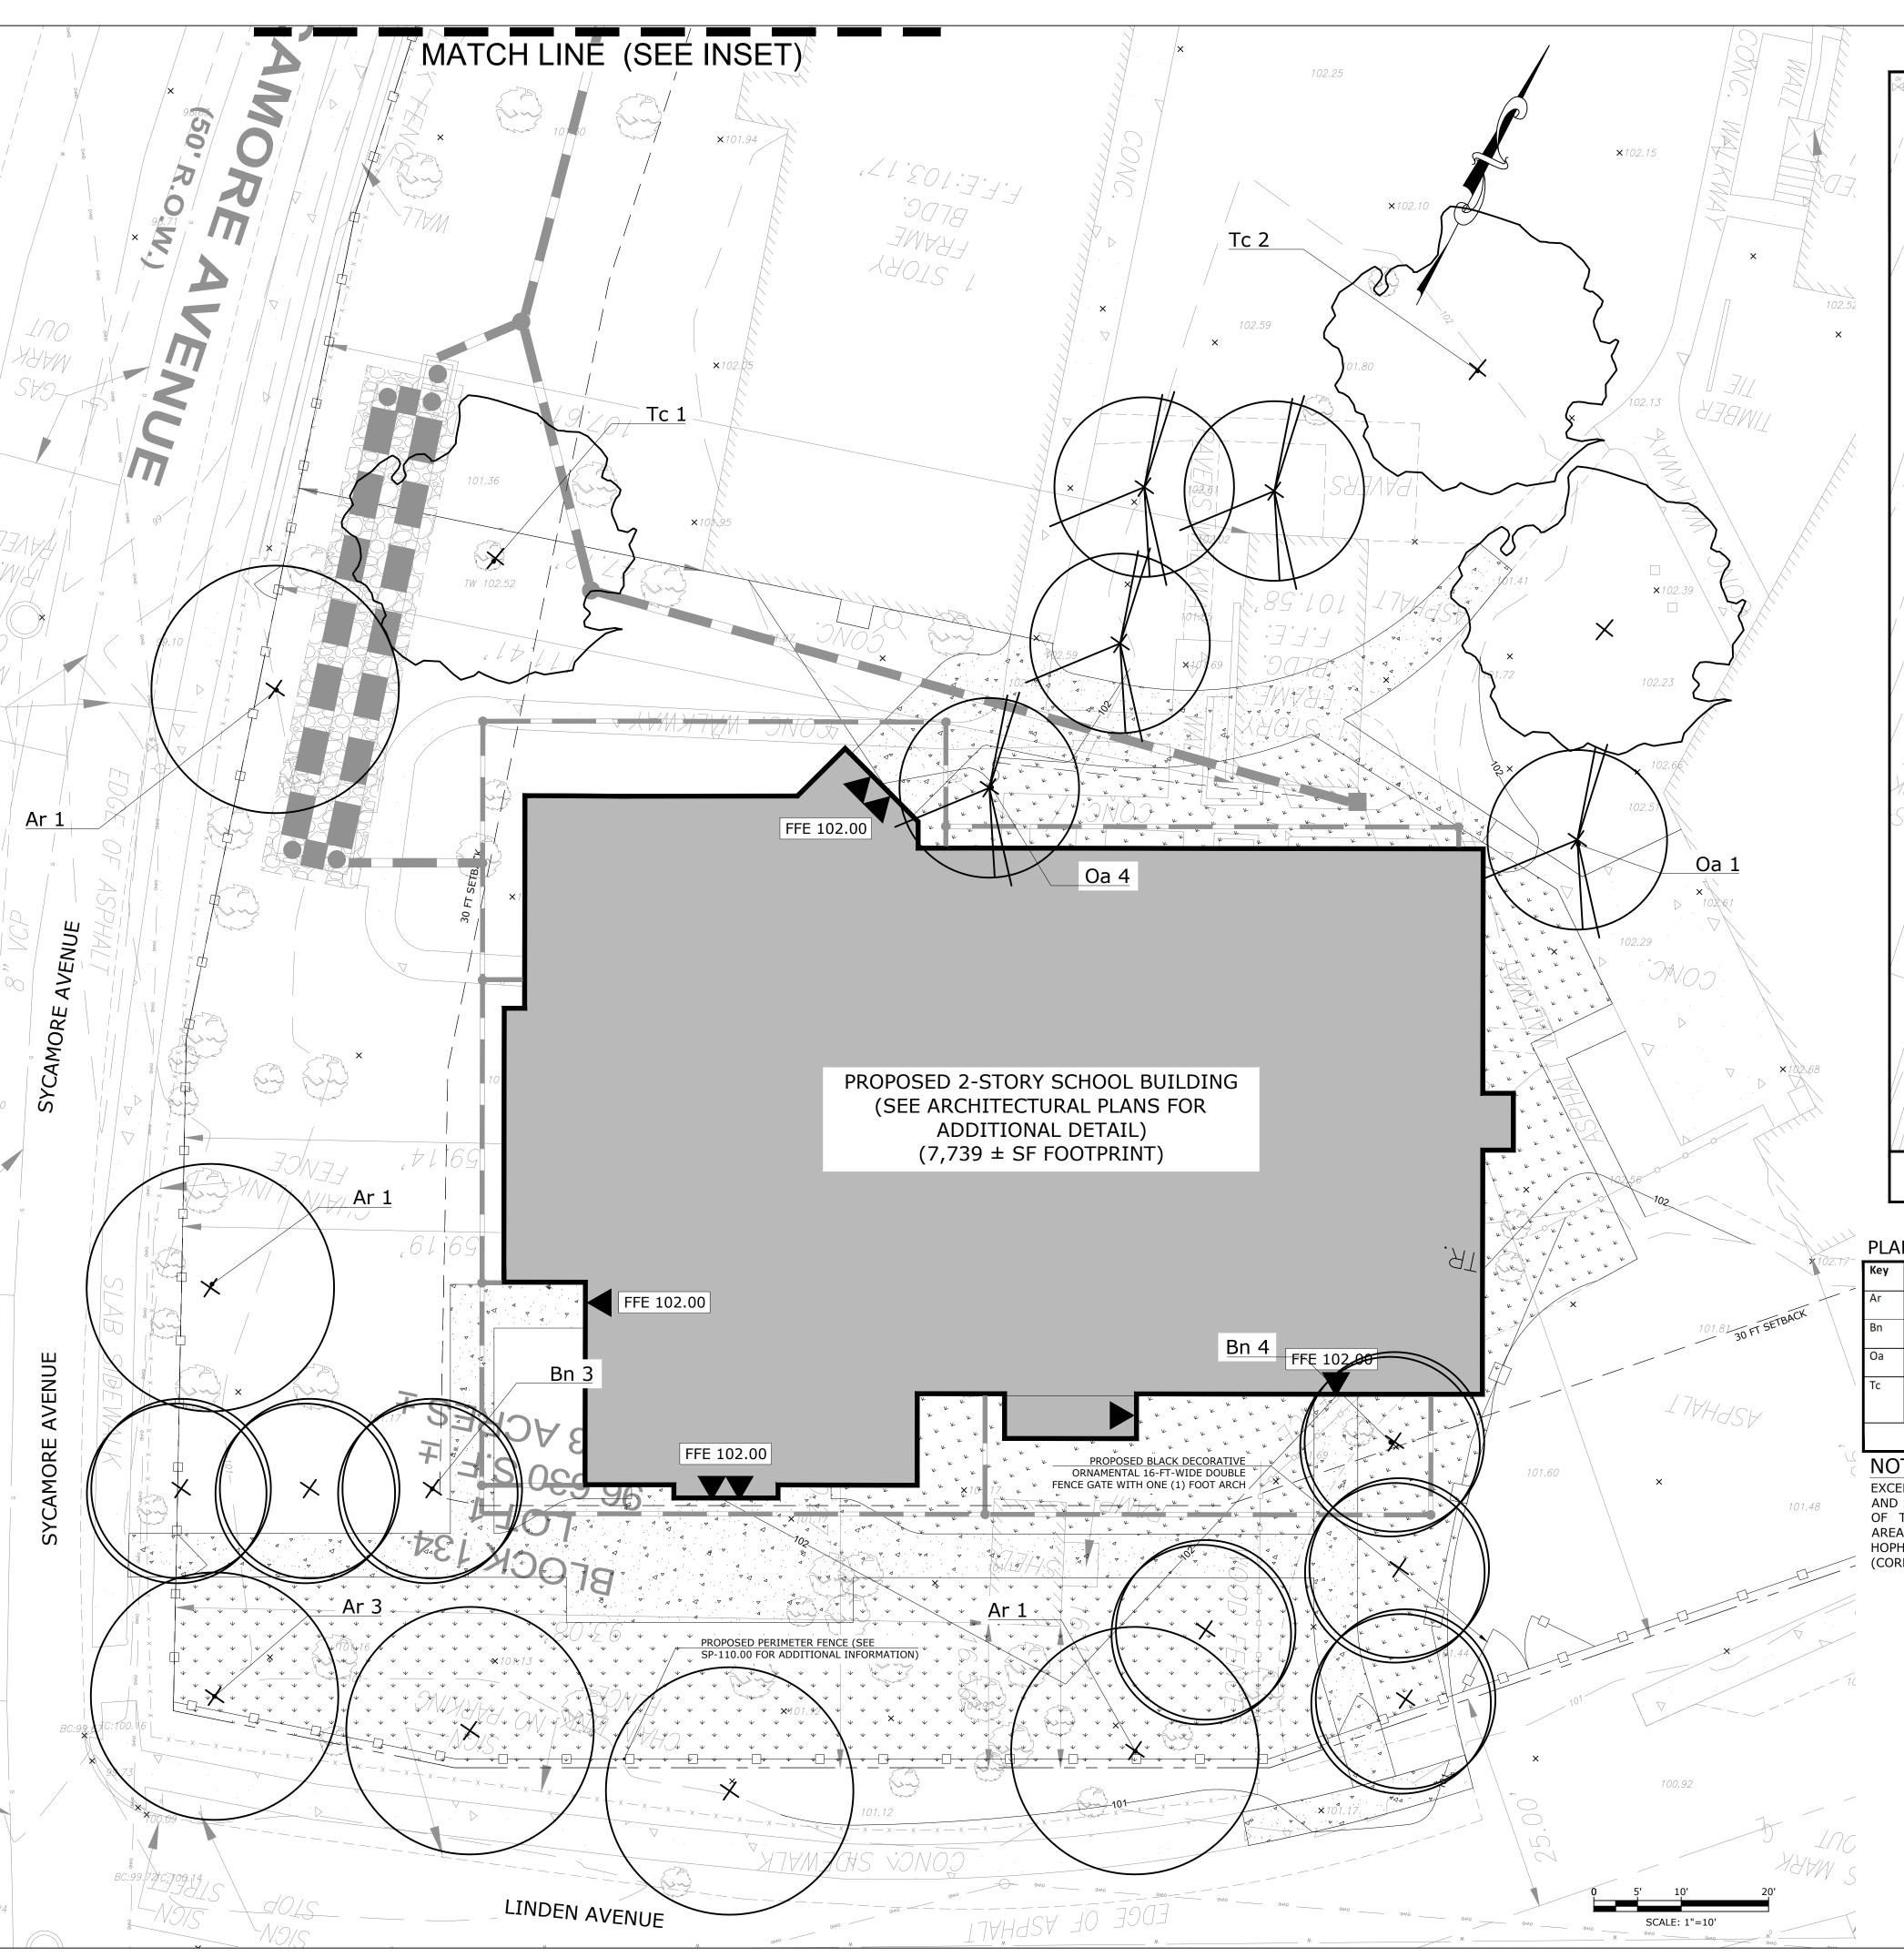

PLANTING LIST

	ey	Quantity	Common Name	Scientific Name	Native	Size/Root	Spacing/Notes
Α	ır	8	October Glory Red Maple	Acer rubrum 'October Glory'	Y	2.5-3" Cal. Min. / B&B	Spaced as Shown
Ві	n	7	Dura-Heat River Birch	Betula nigra 'BNMTF'	Y	2-2.5" Cal. / B&B	Spaced as Shown
0)a	5	Sourwood / Sorrel Tree	Oxydendrum arboreum	Y	2-2.5" Cal. / B&B	Spaced as Shown
To	c	3	Greenspire Littleleaf Linden	Tilia cordata 'Greenspire'	N	2.5-3" Cal. Min. / B&B	Spaced as Shown

EXCEPT FOR GREENSPIRE LINDEN, SPECIES LISTED ABOVE ARE NATIVE (AS RECOMMENDED BY THE BOROUGH) AND SELECTED FOR SIZE, SUITABILITY, LOW MAINTENANCE, AND COLOR SCHEME. WITH POSSIBLE EXCEPTION OF THE SOURWOOD/SORREL TREE, SPECIES LISTED ABOVE ARE READILY-AVAILABLE FROM VARIOUS AREA-WIDE NURSERIES. POTENTIAL SUITABLE SUBSTITUTES FOR THIS SPECIES ONLY INCLUDE AMERICAN HOPHORNBEAM (OSTRYA VIRGINIANA); EASTERN REDBUD (CERCIS CANADENSIS); AND EASTERN DOGWOOD (CORNUS FLORIDA); HOWEVER, NO SUBSTITUTES UNLESS APPROVED BY LANDSCAPE DESIGNER.

DRAWING TITLE

LANDSCAPE PLAN

CHECKED BY: CS	DRAWN BY: ENS
SCALE: 1" = 10'	SHEET NO: 6 OF 15
PROJECT #: P-22-47-01	FIRST ISSUE: 8/24/2022
DRAWING NO	

SP-105.00

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OWNER/APPLICANT YESHIVA TIFERES BORUCH, INC. 112 LINDEN AVENUE NORTH PLAINFIELD, NJ 07060

E 2 PROJECT MANAGEMENT LLC

SCHEDULE OF REVISIONS

REV. DATE DESCRIPTION OF CHANGES

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REGISTERED PROFESSIONAL ENGINEER AND LAND SURVEYOR

YESHIVA NEW ACADEMY BUILDING

> TAX LOT 1 BLOCK 134

21 ROCKVIEW AVENUE BOROUGH OF NORTH PLAINFIELD SOMERSET COUNTY, NJ

SELECTION AND HANDLING OF PLANT MATERIAL

- CONTRACTOR TO VERIFY THAT PLANT LIST(S), PLANT SPECIES, AND QUANTITIES COORDINATE WITH PLANTING PLAN(S). WHERE A DESCREPANCY IS IDENTIFIED, QUANTITIES SPECIFIED ON THE PLAN
- WILL BE OBTAINED AND INSTALLED. CONTRACTOR TO SUPPLY NURSERY SOURCE FOR ALL PLANT MATERIAL. PLANTS SHALL BE SOURCED FROM THE SAME GEOLOGICAL
- REGION. PLANTS WITH UNDERSIZED OR BROKEN ROOT BALLS, EXCESSIVE CURLING AND/OR GIRDLING OF ROOTS, INJURY FROM ROUGH
- TREATMENT, OR DROUGHT STRESS WILL BE REJECTED. PLEASE NOTE: IT IS THE RESPONSIBILITY OF THE CONTRACTOR TO GUARANTEE THAT THE ROOT BALLS ARE PROPERLY SIZED. PLEASE BE AWARE THAT FOR PROPER SIZING, EXCESS ALIEN SOIL SHALL BE REMOVED PRIOR TO DIGGING. SEE DIAGRAM 1.2.
- ROOT BALLS SHALL BE KEPT MOIST AT ALL TIMES. PLANTS SHALL BE COVERED DURING TRANSPORT TO PREVENT DESICCATION FROM WIND. IN WARM WEATHER PLANTS SHALL BE COVERED JUST PRIOR TO TRAVEL AND UNCOVERED IMMEDIATELY UPON REACHING DESTINATION TO AVOID HEAT BUILD UP UNDER THE TARP. PLANT MATERIAL SHALL NOT BE LEFT IN DIRECT SUNLIGHT OR ON HIGH HEAT ABSORPTION MATERIALS, SUCH AS BUT NOT LIMITED TO.

ASPHALT AND/ OR METAL TRUCK BEDS TO PREVENT THE WILTING OF

- MATERIAL. TREES SHALL BE MOVED BY THEIR ROOT BALL NOT THEIR TRUNK. TREES LARGER THAN 6" SHALL BE MOVED WITH PROPER STRAPPING SECURING ROOT BALL TO EQUIPMENT. WEAVE STRAPPING THROUGH THE LACING, NOT AROUND THE TRUNK. TREE TRUNK SHALL BE
- PROTECTED AT ALL TIME FROM COMPRESSION AND SEARING. IF PLANTS ARE NOT PLANTED IMMEDIATELY ON SITE, PROPER CARE SHALL BE TAKEN:
- a.PLACE IN PARTIAL SHADE WHEN POSSIBLE. b.COVER ROOT BALL WITH MOISTENED MULCH OR AGED WOOD CHIPS. c. SUPPLY PROPER IRRIGATION AS NOT TO ALLOW THE ROOT BALL TO DRY OUT.
- d.UNTIE PLANT MATERIAL AND ALLOW PROPER SPACING OF PLANTS FOR AIR CIRCULATION TO PREVENT DISEASE, WILTING, AND LEAF LOSS AND FOR GENERAL HEATH OF PLANTS.
- CONTRACTOR/NURSERY SHALL GUARANTEE HEALTH AND VIGOR OF ALL PLANT MATERIALS FOR A MINIMUM OF ONE (1) YEAR AFTER INSTALLATION.
- 10. ALL INSTALLED PLANT MATERIAL SHALL BE WATERED IN ACCORDANCE WITH THE WATERING SCHEDULE NOTED ON THE PLAN(S).

PERMANENT VEGETATIVE COVER FOR SOIL STABILIZATION

- 1. GRADE AS NEEDED AND FEASIBLE TO PERMIT THE USE OF CONVENTIONAL EQUIPMENT FOR SEEDBED PREPARATION, SEEDING, MULCH APPLICATION, AND MULCH ANCHORING. ALL GRADING SHOULD BE DONE IN ACCORDANCE WITH STANDARD FOR LAND GRADING.
- 2. IMMEDIATELY PRIOR TO SEEDING AND TOPSOIL APPLICATION, THE SUBSOIL SHALL BE EVALUATED FOR COMPACTION IN ACCORDANCE WITH THE STANDARD FOR LAND GRADING .

 3. TOPSOIL SHOULD BE HANDLED ONLY WHEN IT IS DRY ENOUGH TO WORK WITHOUT DAMAGING THE SOIL STRUCTURE. A
- UNIFORM APPLICATION TO A DEPTH OF 5 INCHES (UNSETTLED) IS REQUIRED ON ALL SITES. TOPSOIL SHALL BE AMENDED WITH ORGANIC MATTER, AS NEEDED, IN ACCORDANCE WITH THE STANDARD FOR TOPSOILING. 4. INSTALL NEEDED EROSION CONTROL PRACTICES OR FACILITIES SUCH AS DIVERSIONS, GRADE-STABILIZATION STRUCTURES, CHANNEL STABILIZATION MEASURES, SEDIMENT BASINS, AND WATERWAYS.

SEEDBED PREPARATION

SOIL INTO THE SUBSOIL

- 1. UNIFORMLY APPLY GROUND LIMESTONE AND FERTILIZER TO TOPSOIL WHICH HAS BEEN SPREAD AND FIRMED, ACCORDING TO SOIL TEST RECOMMENDATIONS SUCH AS OFFERED BY RUTGERS CO-OPERATIVE EXTENSION SOIL SAMPLE MAILERS ARE LOOSEN THE EXISTING SOILS TO THE WIDTHS AND DEPTHS SHOWN AVAILABLE FROM THE LOCAL RUTGERS COOPERATIVE EXTENSION OFFICES (HTTP://NJAES.RUTGERS.EDU/COUNTY/). FERTILIZER SHALL BE APPLIED AT THE RATE OF 500 POUNDS PER ACRE OR 11 POUNDS PER 1,000 SQUARE FEET OF 10-10-10 OR EQUIVALENT WITH 50% WATER INSOLUBLE NITROGEN UNLESS A SOIL TEST INDICATES OTHERWISE AND INCORPORATED INTO THE SURFACE 4 INCHES. IF FERTILIZER IS NOT INCORPORATED, APPLY ONE-HALF THE RATE DESCRIBED ABOVE DURING SEEDBED PREPARATION AND REPEAT ANOTHER ONE-HALF RATE APPLICATION OF THE SAME
- FERTILIZER WITHIN 3 TO 5 WEEKS AFTER SEEDING. WORK LIME AND FERTILIZER INTO THE TOPSOIL AS NEARLY AS PRACTICAL TO A DEPTH OF 4 INCHES WITH 4-1 STANDARDS FOR SOIL EROSION AND SEDIMENT CONTROL IN NEW JERSEY JANUARY 2014 A DISC, SPRING-TOOTH HARROW, OR OTHER SUITABLE EQUIPMENT. THE FINAL HARROWING OR DISKING OPERATION SHOULD BE ON THE
- HARROW, OR OTHER SUITABLE EQUITION......

 GENERAL CONTOUR. CONTINUE TILLAGE UNTIL A REASONABLE UNIFORM SEEDBED IS PREPARED.

 3. HIGH ACID PRODUCING SOIL. SOILS HAVING A PH OF 4 OR LESS OR CONTAINING IRON SULFIDE SHALL BE COVERED WITH

 A MINIMUM OF 12 INCHES OF SOIL HAVING A PH OF 5 OR MORE BEFORE INITIATING SEEDBED REPARATION. SEE

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 THE MORTH IN THE FIELD OF THE PROPERTY IN THE FIELD OF THE MORTH IN THE F

- 1. SELECT A MIXTURE FROM TABLE 4-3 OR USE A MIXTURE RECOMMENDED BY RUTGERS COOPERATIVE EXTENSION OR NATURAL RESOURCES CONSERVATION SERVICE WHICH IS APPROVED BY THE SOIL CONSERVATION DISTRICT. SEED GERMINATION SHALL HAVE BEEN TESTED WITHIN 12 MONTHS OF THE PLANTING DATE. NO SEED SHALL BE ACCEPTED WITH A GERMINATION TEST DATE MORE THAN 12 MONTHS OLD UNLESS RETESTED.
- 1.1. SEEDING RATES SPECIFIED ARE REQUIRED WHEN A REPORT OF COMPLIANCE IS REQUESTED PRIOR TO ACTUAL FSTABLISHMENT OF PERMANENT VEGETATION. UP TO 50% REDUCTION IN RATES MAY BE USED WHEN PERMANENT VEGETATION IS ESTABLISHED PRIOR TO A REPORT OF COMPLIANCE INSPECTION. THESE RATES APPLY TO ALL METHODS OF SEEDING. ESTABLISHING PERMANENT VEGETATION MEANS 80% VEGETATIVE COVERAGE WITH THE SPECIFIED SEED MIXTURE FOR THE SEEDED AREA AND MOWED ONCE.
- 1.2. WARM-SEASON MIXTURES ARE GRASSES AND LEGUMES WHICH MAXIMIZE GROWTH AT HIGH TEMPERATURES, GENERALLY 850 F AND ABOVE. SEE TABLE 4-3 MIXTURES 1 TO 7. PLANTING= RATES FOR WARM-SEASON GRASSES SHALL BE THE AMOUNT OF PURE LIVE SEED (PLS) AS DETERMINED BY GERMINATION TESTING RESULTS 1.3. COOL-SEASON MIXTURES ARE GRASSES AND LEGUMES WHICH MAXIMIZE GROWTH AT TEMPERATURES BELOW 850. MANY GRASSES BECOME ACTIVE AT 650 SEE TABLE 4-3, MIXTURES 8-20. ADJUSTMENT OF PLANTING RATES TO
- COMPENSATE FOR THE AMOUNT OF PLS IS NOT REQUIRED FOR COOL SEASON GRASSES. 2. CONVENTIONAL SEEDING IS PERFORMED BY APPLYING SEED UNIFORMLY BY HAND, CYCLONE (CENTRIFUGAL) SEEDER, DROP SEEDER, DRILL OR CULTIPACKER SEEDER. EXCEPT FOR DRILLED, HYDROSEEDED OR CULTIPACKED SEEDINGS, SEED
 SHALL BE INCORPORATED INTO THE SOIL WITHIN 24 HOURS OF SEEDBED PREPARATION TO A DEPTH OF 1/4 TO 1/2 INCH, TAPERED SIDES BY RAKING OR DRAGGING, DEPTH OF SEED PLACEMENT MAY BE 1/4 INCH DEEPER ON COARSE-TEXTURED SOIL 3. AFTER SEEDING, FIRMING THE SOIL WITH A CORRUGATED ROLLER WILL ASSURE GOOD SEED-TO-SOIL CONTACT, RESTORE CAPILLARITY, AND IMPROVE SEEDLING EMERGENCE. THIS IS THE PREFERRED METHOD. WHEN PERFORMED ON THE
- CONTOUR, SHEET EROSION WILL BE MINIMIZED AND WATER CONSERVATION ON SITE WILL BE MAXIMIZED. . HYDROSEEDING IS A BROADCAST SEEDING METHOD USUALLY INVOLVING A TRUCK, OR TRAILER-MOUNTED TANK, WITH AN AGITATION SYSTEM AND HYDRAULIC PUMP FOR MIXING SEED, WATER AND FERTILIZER AND SPRAYING THE MIX ONTO THE PREPARED SEEDBED, MULCH SHALL NOT BE INCLUDED IN THE TANK WITH SEED, SHORTFIBERED MUICH MAY BE APPLIED WITH A HYDROSEEDER FOLLOWING SEEDING. (ALSO SEE SECTION 4-MULCHING BELOW), HYDROSEEDING IS NOT A PREFERRED SEEDING METHOD BECAUSE SEED AND FERTILIZER ARE APPLIED TO THE SURFACE AND NOT INCORPORATED INTO THE SOIL. WHEN POOR SEED TO SOIL CONTACT OCCURS, THERE IS A REDUCED SEED GERMINATION AND GROWTH.

STANDARD ROOT BALL SIZES FOR NURSERY-GROWN SHADE TREES

CALIPER*	HEIGHT RANGE (FT-IN.)	MAX. HEIGHT (FT)	MIN. BALL DIA. (IN.)	MIN. BALL DEPTH (IN.)
1/2	5-6	8	12	9
3/4	6-8	10	14	10 /2
1	8-10	11	16	12
1/4	8-10	12	18	13/2
1½	10-12	14	20	13/2
1 3/4	10-12	14	22	14 1/2
2	12-14	16	24	16
2 ½	12-14	16	28	18 1/2
3	14-16	18	32	19/2
3 ½	14-16	18	38	23
4	16-18	22	42	25
5	18-20	26	54	32 ½

* UP TO AND INCLUDING THE 4-IN. CALIPER SIZE, THE CALIPER MEASUREMENT INDICATES THE DIAMETER OF THE TRUNK 6 IN. ABOVE GROUND LEVEL. FOR LARGER SIZES, THE CALIPER MEASUREMENT IS TAKEN 12 IN. ABOVE GROUND LEVEL.

1. SEE AMERICAN STANDARD FOR NURSERY STOCK, ANSI Z60.1, FOR COMPLETE LIST OF NURSERY STANDARDS FOR OTHER TYPES AND SIZES OF TREES AND SHRUBS.

2. SEE INTERNATIONAL SOCIETY OF ARCHITECTURE'S "PRINCIPLES AND PRACTICES OF PLANTING TREES AND SHRUBS." 1997

SOIL IMPROVEMENT

THE OUALITY OF SOIL AVAILABLE FOR PLANTING VARIES WIDELY FROM SITE TO SITE, ESPECIALLY AFTER CONSTRUCTION ACTIVITY HAS OCCURRED. THE NATURE OF CONSTRUCTION RESULTS IN COMPACTION, FILLING, CONTAMINATION, AND GRADING OF THE ORIGINAL SOIL ON A SITE, RAPIDLY MAKING IT USELESS FOR PLANTING. PREVIOUS HUMAN ACTIVITY AT A SITE CAN ALSO AFFECT THE ABILITY OF THE SOIL TO

DURING THE DESIGN PHASE, ASSUMPTIONS MUST BE MADE REGARDING THE PROBABLE CONDITION OF THE SOIL AFTER CONSTRUCTION IS COMPLETE. THE HEALTH OF EXISTING OR REMAINING SOIL DETERIMINES WHAT TYPES OF SOIL PREPARATION WILL BE REOUIRED AND THE VOLUME OF SOIL TO BE PREPARED. CONDITIONS WILL VARY FROM LOCATION TO LOCATION WITHIN A PROJECT, AND DETAILS MUST BE CONDITION-SPECIFIC FOR LARGE PROJECTS OR EXTREME CONDITIONS, IT IS USEFUL TO CONSUL AN EXPERT EXPERIENCED IN MODIFYING PLANTING SOILS AT URBAN SITES.

1. IF SITE OR DESIGN CONSTRAINTS PROHIBIT USE OF THE DIMENSIONS SHOWN IN THE PLANTING DETAILS, FOLLOW THE GUIDELINES FOR


2. WHENEVER POSSIBLE THE SOIL IMPROVEMENT AREA SHOULD BE

3. ALWAYS TEST SOIL FOR PH AND NUTRIENT LEVELS AND ADJUST

4. LOOSEN SOIL WITH A BACKHOE OR OTHER LARGE COARSE-TILING EQUIPMENT WHEN POSSIBLE. TILING THAT PRODUCES LARGE, COARSE CHUNKS OF SOIL IS PREFERABLE TO TILING THAT RESULTS IN FINE GRAINS UNIFORM IN TEXTURE.

5. THE BOTTOM OF PLANTING SOIL EXCAVATIONS SHOULD BE ROUGH TO AVOID MATTING OF SOIL LAYERS AS NEW SOIL IS ADDED. IT IS PREFERABLE TO FILL THE FIRST LIFT (2 TO 3 IN.) OF PLANTING

THE MANUFACTURER.

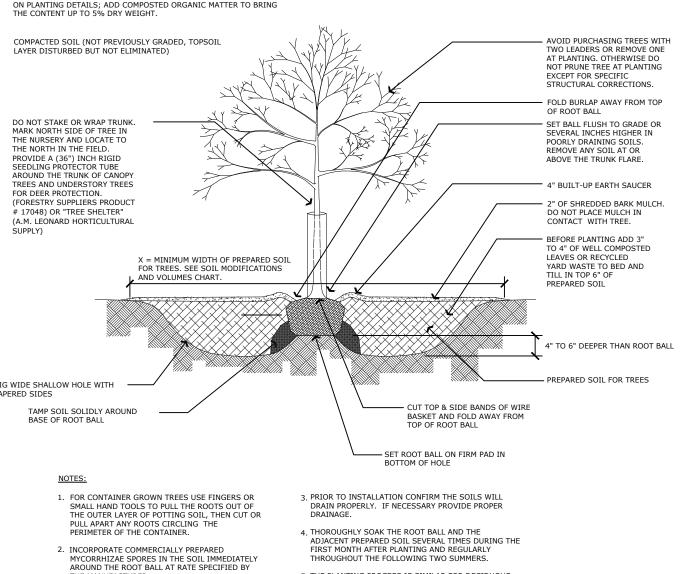


TREE PLANTING DETAIL

THROUGHOUT THE FOLLOWING TWO SUMMERS. 5. THE PLANTING PROCESS IS SIMILAR FOR DECIDUOUS



PERMANENT VEGETATIVE MIXTURES, PLANTING RATES AND PLANTING DATES													
	PLANTING RATES			PLANTING DATES O - OPTIMAL PLANTING PERIOD A - ACCEPTABLE PLANTING PERIOD PLANT HARIDNESS ZONE						MAINTENANCE LEVEL			
SEED MIXTURE			ZO	NE 5B,	6A	ZONE 6B		ZONE 7A, 7B		7B	TEV EVI	REMARKS	
	LBS/ ACRE	LBS/1000 SQ.FT.	3/15 -5/31	6/1 -7/31	8/1 -10/1	3/1 -4/30	5/1 -8/14	8/15 -10/15	2/1 -4/30	5/1 -8/14	8/15 -10/30	MAIN	
					WARM	SEASO	MIXTU	JRE #4					
SWITCHGRASS	10	.25											
BIG BLUESTEM	5	.10											
LITTLE BLUESTEM	5	.10	0			0			0			C-D	NATIVE WARM SEASON MIXTURE
SAND LOVEGRASS	4	.10											SEASONTIATORE
COSTAL PANICGRASS	10	.20											
					COOL S	EASON	MIXTU	RE #7					
STRONG CREEPING RED FESCUE	130	3											SUITABLE WATERWAY
KENTUCKY BLUEGRASS	50	1											CANADA BLUEGRASS
PERENNIAL RYEGRASS OR	20	.60	Α	Α	0	Α	Α	0	Α	Α	О	B-D	MORE DROUGHT TOLERANT
REDTOP	10	.25											USE REDTOP FOR INCREASED DROUGHT
PLUS WHITE CLOVER	5	.10											TOLERANCE

WATERING	SCHEDULE			
Maintenance Item	Schedule	Rate	Inspection Requirement	Maintenance Requirement
Watering	Weekly – Early Morning	Minimum One (1) Inch	Weekly – During First Growing Season or Until Vegetation Becomes Established. Inspect for Dry Soils, Wilted Vegetation.	Increase Watering Frequency / Rate to Maintain Soil Moisture and Plant Vigor.

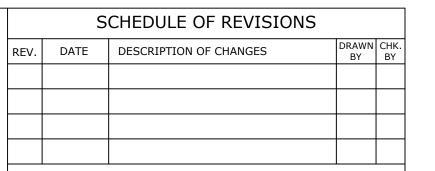

OWNER/APPLICANT YESHIVA TIFERES BORUCH, INC. 112 LINDEN AVENUE NORTH PLAINFIELD, NJ 07060

E 2 PROJECT MANAGEMENT LLC

87 HIBERNIA AVENUE ROCKAWAY, N.J. 07866 PHONE: (973) 299-5200 FAX: (973) 299-5059 www.E2PM.com

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N.J. ENGINEERING CERTIFICATE OF AUTHORIZATION No. 24GA28118200

> I CERTIFY THAT THESE PLANS HAVE BEEN PREPARED UNDER MY SUPERVISION

CHARLES J. STEWART, P.E., P.L.S. N.J. NO. 24GB03588400 REGISTERED PROFESSIONAL ENGINEER AND LAND SURVEYOR

PROJECT NAME

YESHIVA NEW ACADEMY BUILDING

TAX LOT 1 BLOCK 134

21 ROCKVIEW AVENUE BOROUGH OF NORTH PLAINFIELD SOMERSET COUNTY, NJ


DRAWING TITLE

LANDSCAPING DETAILS

CHECKED BY:	CS	DRAWN BY: ENS		
SCALE:	AS SHOWN	SHEET NO: 7 OF 15		
PROJECT #: P-2	22-47-01	FIRST ISSUE: 8/24/2022		

DRAWING NO.

SP-106.00

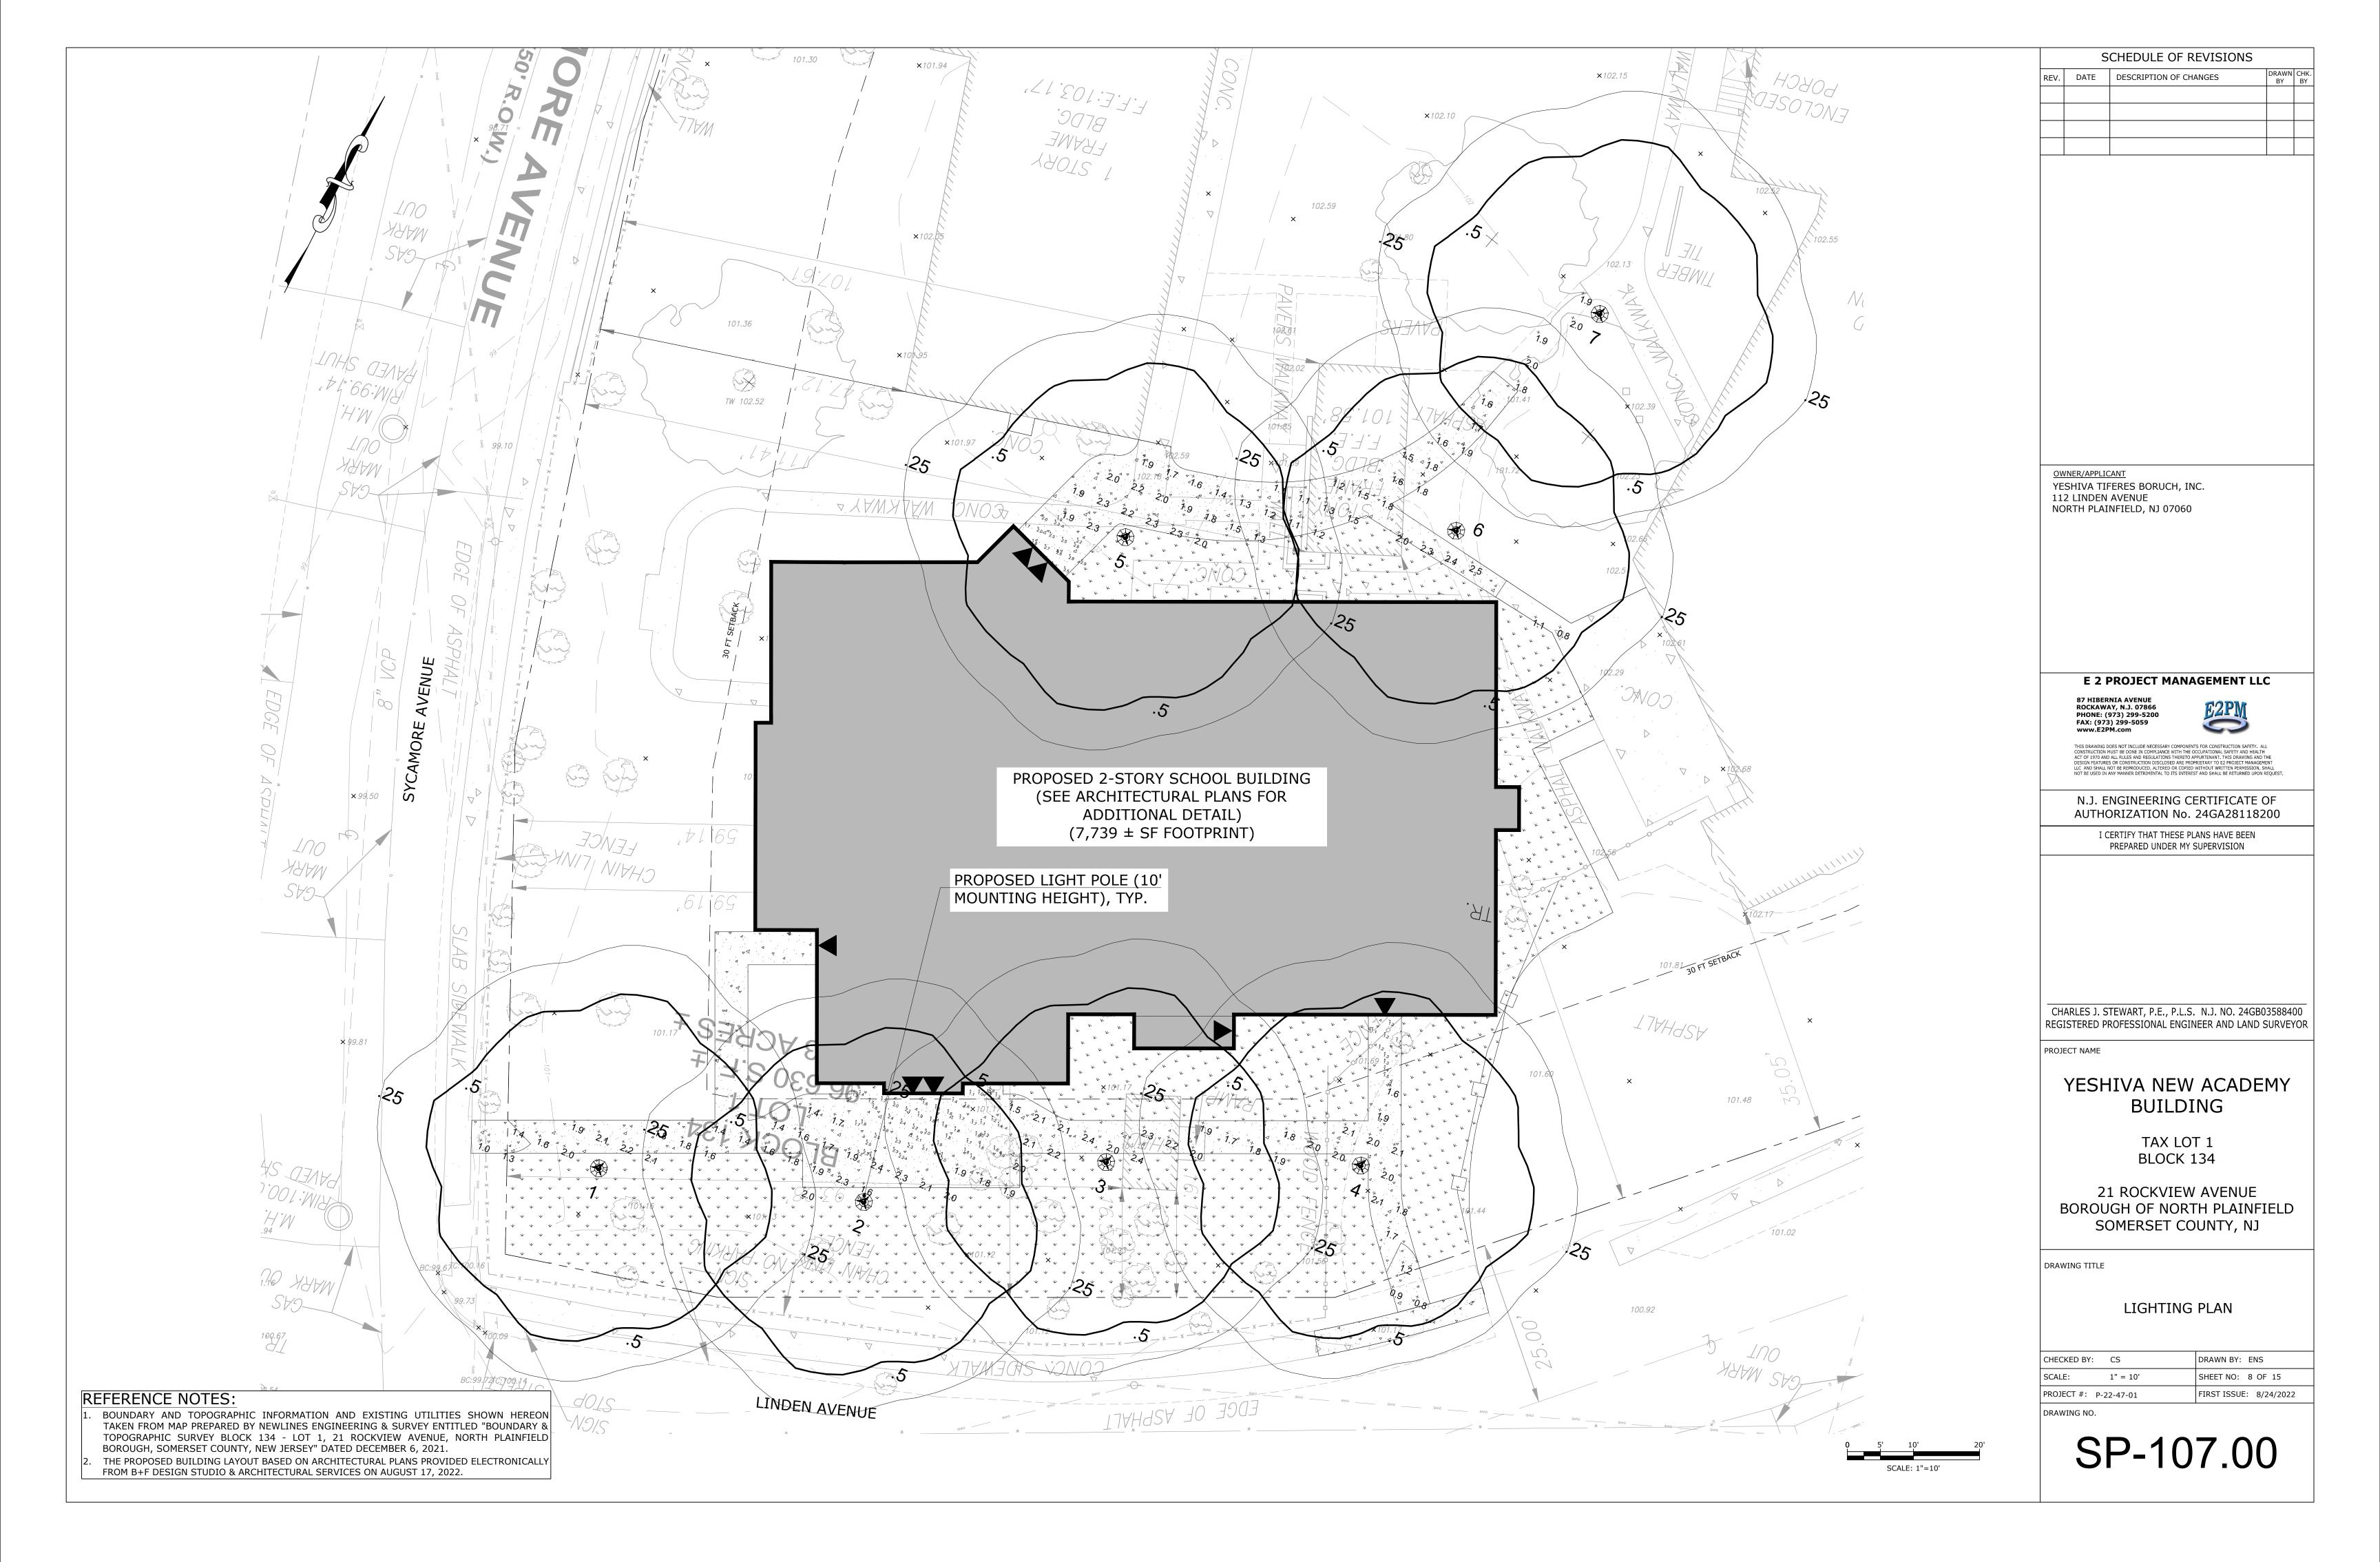

LIGHTING SCHEDULE

Calculation Summary												
Project: Project_1												
Label	CalcType	Units	Avg	Max	Min	Avg/Min	Max/Min	Description	PtSpcLr	PtSpcTb	Meter Type	
CalcPts_Walkway North	Illuminance	Fc	1.73	2.5	0.8	2.16	3.13	Readings taken @ 0'-0" AFG	4	4	Horizontal	
CalcPts_Walkway South	Illuminance	Fc	1.84	2.4	0.8	2.30	3.00	Readings taken @ 0'-0" AFG	4	4	Horizontal	
StatArea_North Entrance Steps	Illuminance	Fc	2.34	3.5	1.7	1.38	2.06	Readings taken on Stair Tread				
StatArea_SE Entrance Steps	Illuminance	Fc	1.26	1.5	1.1	1.15	1.36	Readings taken on Stair Tread				
StatArea South Entrance Steps	Illuminance	Fc	1.81	2.6	0.8	2.26	3.25	Readings taken on Stair Tread				

I	Luminaire S	chedule									
;	Symbol	Tag	Qty	Label	Arrangement	Lum. Lumens	LLF	Description	Lum. Watts	Total Watts	BUG Rating
	A	Α	7	ALED5T26Y-D10	Single	3395	1.000	Post top mount, 3000k CCT	26.3789	184.652	B2-U0-G1

LumNo	Tag	X	Υ	Z	Orient	Tilt
1	Α	10874.266	9834.459	10	0	0
2	Α	10913.275	9845.013	10	0	0
3	Α	10944.874	9864.525	10	0	0
4	Α	10980.701	9878.703	10	0	0
5	Α	10911.6	9953.042	10	0	0
6	Α	10957.493	9972.981	10	0	0
7	Α	10965.098	10011.571	10	0	0

LIGHTING NOTES

* The light loss factor (LLF) is a product of many variables, only lamp lumen depreciation (LLD) has been applied to the calculated results unless otherwise noted. The LLD is the result (quotient) of mean lumens / initial lumens per lamp manufacturers' specifications.

* Illumination values shown (in footcandles) are the predicted results for planes of calculation either horizontal, vertical or inclined as designated in the calculation summary. Meter orientation is normal to the plane of calculation.

* The calculated results of this lighting simulation represent an anticipated prediction of system performance. Actual measured results may vary from the anticipated performance and are subject to means and methods which are beyond the control of RAB Lighting Inc.

* Mounting height determination is job site specific, our lighting simulations assume a mounting height (insertion point of the luminaire symbol) to be taken at the top of the symbol for ceiling mounted luminaires and at the bottom of the symbol for all other luminaire mounting configurations.

* It is the Owner's responsibility to confirm the suitability of the existing or proposed poles and bases to support the proposed fixtures, based on the weight and EPA of the proposed fixtures and the owner's site soil conditions and wind zone. It is recommended that a professional engineer licensed to practice in the state the site is located be engaged to assist in this determination.


* The landscape material shown hereon is conceptual, and is not intended to be an accurate representation of any particular plant, shrub, bush, or tree, as these materials are living objects, and subject to constant change. The conceptual objects shown are for illustrative purposes only. The actual illumination values measured in the field will vary.

* Photometric model elements such as buildings, rooms, plants, furnishings or any architectural details which impact the dispersion of light must be detailed by the customer documents for inclusion in the RAB lighting design model. RAB is not responsible for any inaccuracies caused by incomplete information on the part of the customer, and reserves the right to use best judgement when translating customer requests into photometric studies.


* RAB Lighting Inc. luminaire and product designs are protected under U.S. and International intellectual property laws. Patents issued or pending apply.

The Lighting Analysis, ezLayout, Energy Analysis and/or Visual Simulation ("Lighting Design") provided by RAB Lighting Inc. ("RAB") represents an anticipated prediction of lighting system performance based upon design parameters and information supplied by others. These design parameters and information provided by others have not been field verified by RAB and therefore actual measured results may vary from the actual field conditions. RAB recommends that design parameters and other information be field verified to reduce variation.

RAB neither warranties, either implied or stated with regard to actual measured light levels or energy consumption levels as compared to those illustrated by the Lighting Design. RAB neither warranties, either implied or stated, nor represents the appropriateness, completeness or suitability of the Lighting Design intent as compliant with any applicable regulatory code requirements with the exception of those specifically stated on drawings created and submitted by RAB. The Lighting design is issued, in whole or in part, as advisory documents for informational purposes and is not intended for construction nor as being part of a project's construction documentation package.

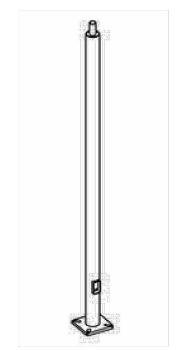


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PR4-11-10WT

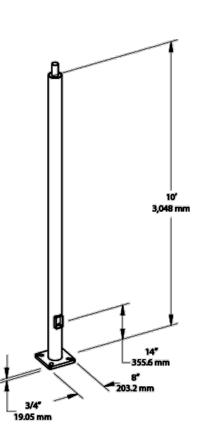
RAB



Compliance	Color:	Shaft Size:		
CSA Listed:	Bronze powder coating	4 "		
Suitable for wet locations	Tenon:	Anchor Bolt Templates:		
Performance	Welded 2 3/8" tenon included	WARNING Template must be printed on 11" x 17"		
Description:	Height:	sheet for actual size. CHECK SCALE BEFORE USING. Templates shipped with anchor bolts and available		
Steel pole 4" round 11 gauge 10 foot welded tenon square base	10 FT	online.		
	Gauge:	Max EPA's/Max Weights:		
Construction	11	70MPH 19.1 ft./700 lb.		
Shaft:	Wall Thickness:	80MPH 14.4 ft./620 lb.		
46,000 p.s.i. minimum yield.	1/8"	90MPH 11.1 ft./585 lb. 100MPH 8.7 ft./445 lb.		
Hand Holes:		110MPH 7.0 ft./370 lb.		
Reinforced with grounding lug and removable cover		120MPH 5.7 ft./335lb. 130MPH 4.6 ft./300 lb.		
Base Plates:		140MPH 3.8 ft./265 lb.		
Slotted base plates 36,000 p.s.i.		150MPH 3.1 ft./180 lb		
Stotted Sase plates solodo p.s.ii.		Accessories:		
		Base/Cap: BASE-R4		
		Anchor Bolts: <u>BOLT4/11</u>		

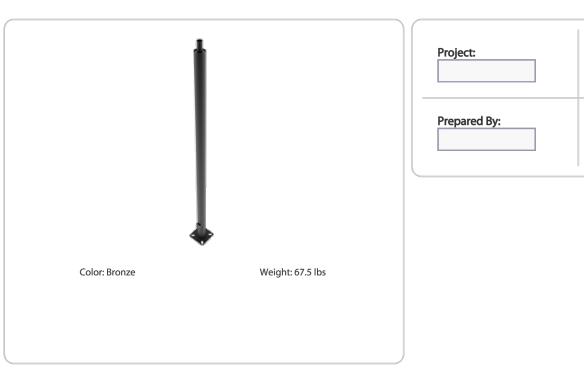Need help? Tech help line: (888) 722-1000 Email: sales@rablighting.com Website: www.rablighting.com Copyright © 2022 RAB Lighting All Rights Reserved Note: Specifications are subject to change at any time without notice


Page 1 of 2

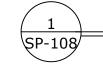


LIGHT POLE DETAIL AND CUT SHEET


SCALE: N.T.S.

ALED5T26Y

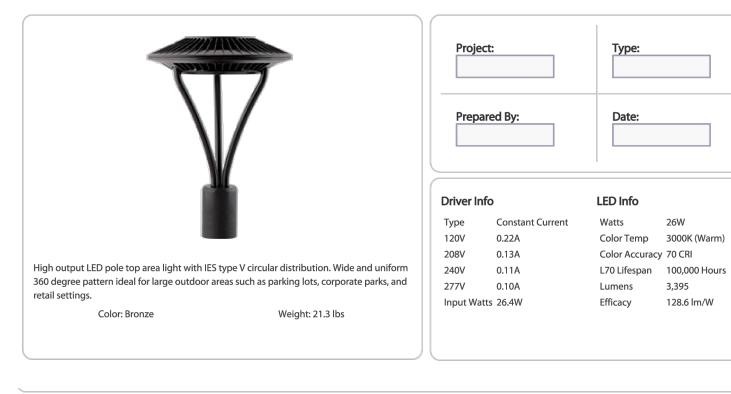

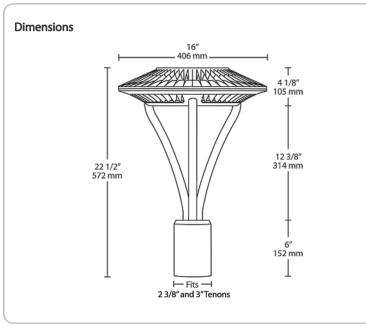

LIGHT FIXTURE DETAIL

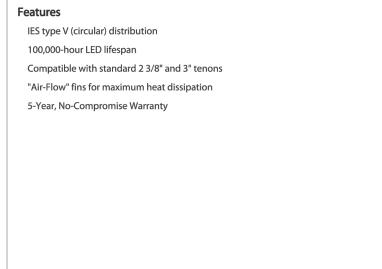



SCALE: N.T.S.

E 2 PROJECT MANAGEMENT LLC

YESHIVA TIFERES BORUCH, INC.

NORTH PLAINFIELD, NJ 07060

87 HIBERNIA AVENUE ROCKAWAY, N.J. 07866 PHONE: (973) 299-5200 www.E2PM.com

OWNER/APPLICANT

112 LINDEN AVENUE

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N.J. ENGINEERING CERTIFICATE OF AUTHORIZATION No. 24GA28118200

SCHEDULE OF REVISIONS

REV. DATE DESCRIPTION OF CHANGES

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YESHIVA NEW ACADEMY BUILDING

TAX LOT 1 BLOCK 134


21 ROCKVIEW AVENUE BOROUGH OF NORTH PLAINFIELD SOMERSET COUNTY, NJ

DRAWING TITLE

LIGHTING DETAILS

CHECKED BY:	CS	DRAWN BY: ENS	
SCALE:	AS NOTED	SHEET NO: 9 OF 15	
PROJECT #: P-2	2-47-01	FIRST ISSUE: 8/24/202	2
DD AVAING NO			

SP-108.00

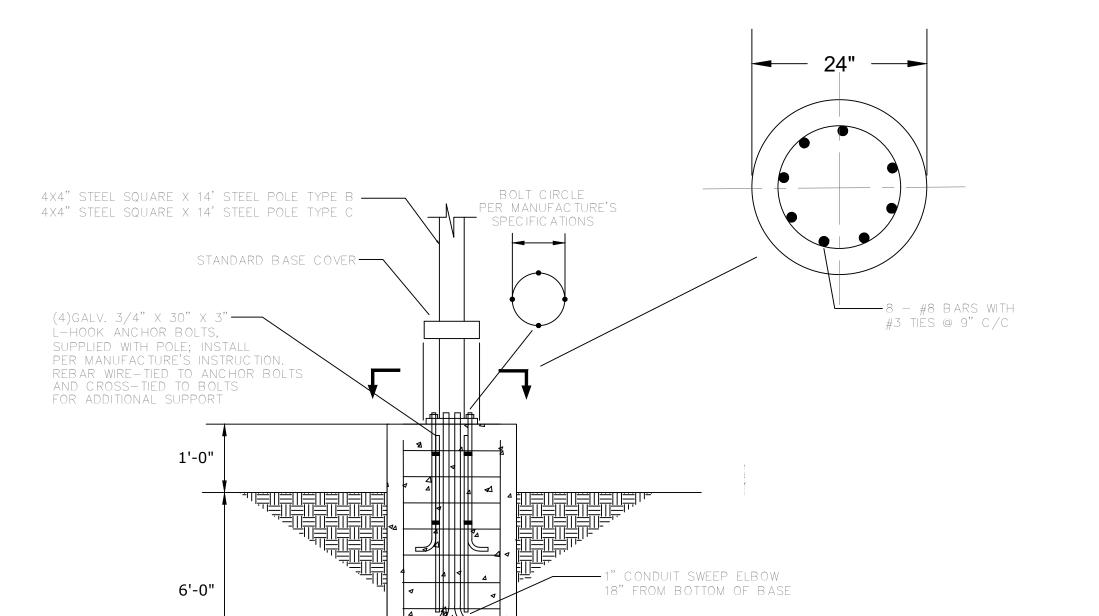

- CONCRETE FOOTING REINFORCED W/


3,000 P.S.I. COMPRESSIVE STRENGTH


SCALE: N.T.S.

(4) 5', #4 VERTICAL REBAR

— 24" DIA. X 6' CONCRETE BASE



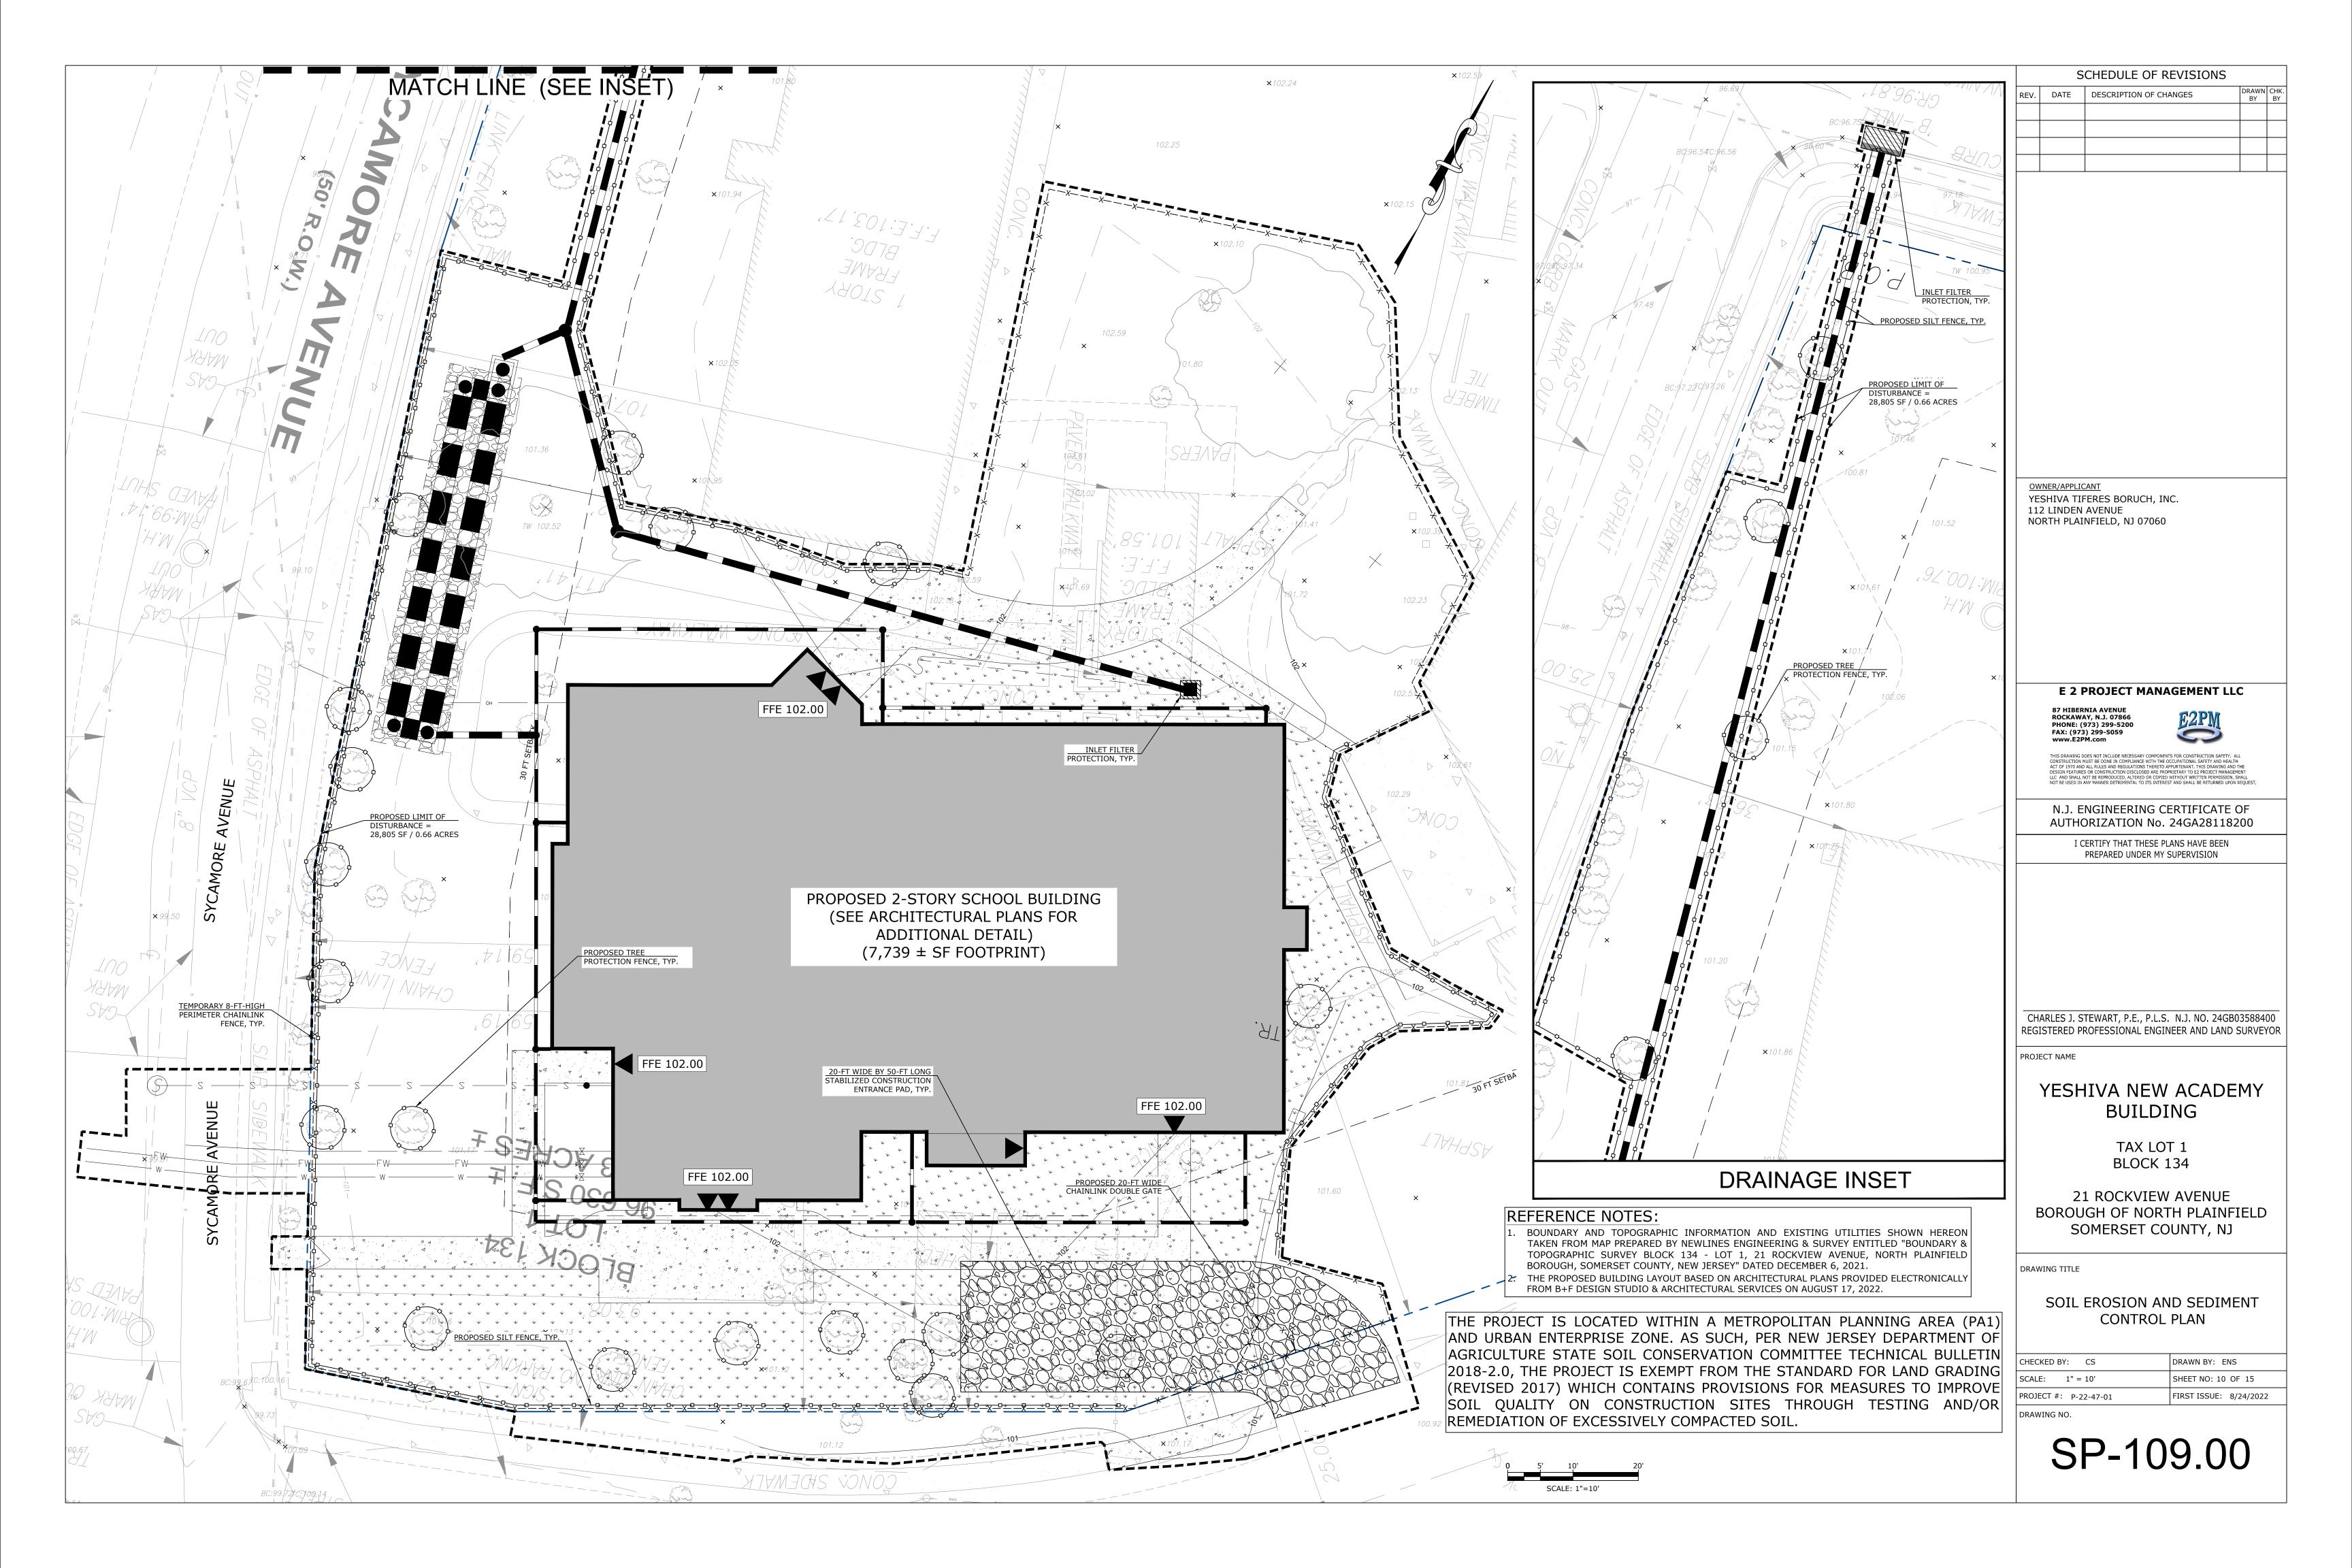

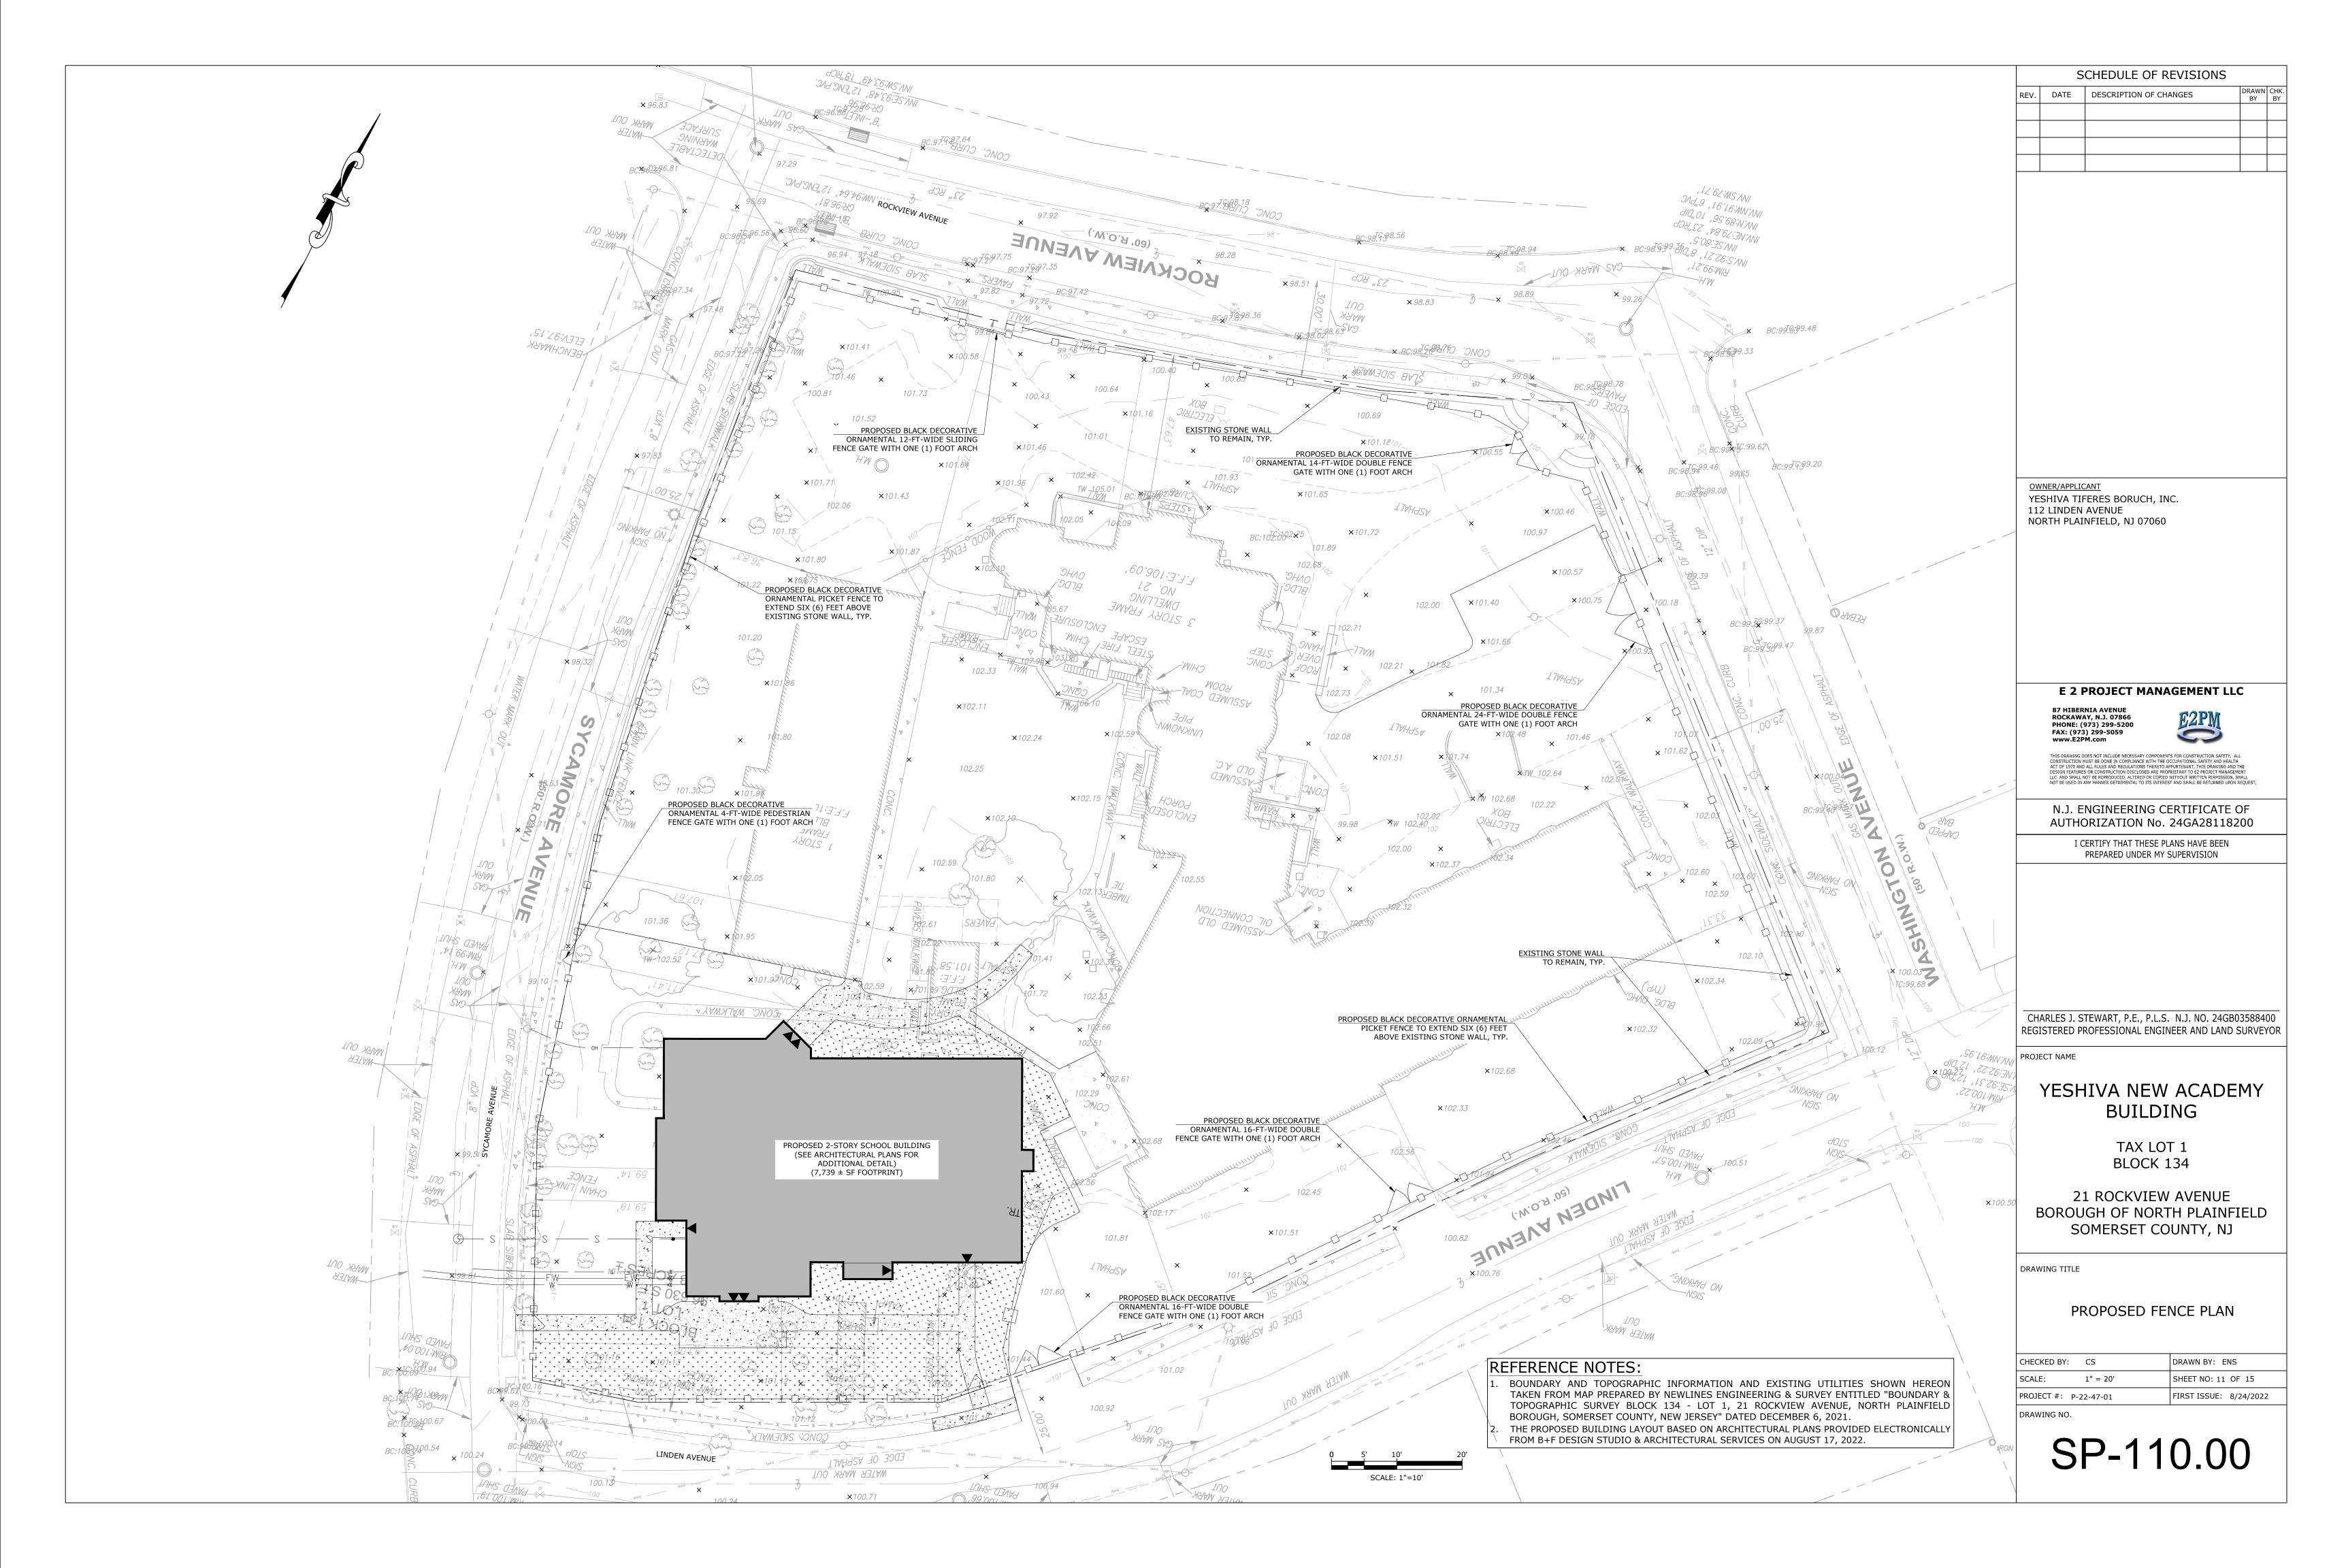

SOMERSET-UNION SOIL CONSERVATION DISTRICT SOIL **EROSION AND SEDIMENT CONTROL NOTES**

- 1. THE SOMERSET-UNION SOIL CONSERVATION DISTRICT SHALL BE NOTIFIED IN WRITING 48 HOURS IN ADVANCE OF ANY LAND DISTURBING ACTIVITY.
- 2. ALL SOIL EROSION AND SEDIMENT CONTROL PRACTICES SHALL BE INSTALLED PRIOR TO ANY MAJOR SOIL DISTURBANCES, OR IN THEIR PROPER SEQUENCE AND MAINTAINED UNTIL PERMANENT PROTECTION IS ESTABLISHED.

PERCENT SLOPE

0 TO 2%

2% TO 5%

>5%

EXISTING GROUND

EXISTING -

GROUND

SEDIMENT BARRIER

(TYPICAL)

SEDIMENT BARRIER

(BALES OR SILT FENCE)

(TYPICAL)

(BALES OR SILT FENCE)

6" MIN.

PROFILE (N.T.S.)

LENGTH ACCORDING TO TABLE

PLAN VIEW (N.T.S.)

TEMPORARY STABILIZED

CONSTRUCTION ENTRANCE

PROVIDE APPROPRIATE

STABILIZED CONSTRUCTION

ENTRANCE AND PUBLIC R.O.W.

25'R

WAY -

*¬*VARIABLE

STOCKPILE

STOCKPILE

SECTION X- X

χ-

χ-

PLAN VIEW

2. STOCKPILES NOT TO BE PLACED IN AREA WITH CONCENTRATED FLOW

TYPICAL STOCKPILE CONSTRUCTION

N.T.S.

wer

TREE PROTECTION FENCE

WETLANDS, EXTREME SLOPE, OR WITHIN 100 FEET OF A NATURAL STREAM. 3. TOPSOIL IS TO BE STOCKPILED SEPARATELY FROM OTHER EXCAVATED MATERIALS

1. STOCKPILES TO BE PLACED AS DETERMINED IN THE FIELD

EXISTING GRADÉ

STOCKPILE TOP AND SIDES TO BE IMMEDIATELY STABILIZED WITH

SLOPE

EMPORARY SEED, ETC.. AS SPECIFIED

SNOW FENCE TO BE PLACED AT DRIP LINE OF TREES.

TRANSITION BETWEEN

OF ROADWAY

- 3. ANY DISTURBED AREAS THAT WILL BE LEFT EXPOSED MORE THAN 30 DAYS AND NOT SUBJECT TO CONSTRUCTION TRAFFIC, WILL IMMEDIATELY RECEIVE A TEMPORARY SEEDING. IF THE SEASON PREVENTS THE ESTABLISHMENT OF A TEMPORARY COVER, THE DISTURBED AREAS WILL BE MULCHED WITH STRAW, OR EOUIVALENT MATERIAL, AT A RATE OF TWO (2) TONS PER ACRE, ACCORDING TO NJ STATE STANDARDS
- 4. PERMANENT VEGETATION SHALL BE SEEDED OR SODDED ON ALL EXPOSED AREAS WITHIN TEN (10) DAYS AFTER FINAL GRADING. MULCH WILL BE USED FOR PROTECTION UNTIL SEEDING IS **ESTABLISHED**
- 5. ALL WORK SHALL BE DONE IN ACCORDANCE WITH THE NJ STATE STANDARDS FOR SOIL EROSION AND SEDIMENT CONTROL IN NEW JERSEY.
- 6. A SUB-BASE COURSE WILL BE APPLIED IMMEDIATELY FOLLOWING ROUGH GRADING AND INSTALLATION OF IMPROVEMENTS IN ORDER TO STABILIZE STREETS, ROADS, DRIVEWAYS AND PARKING AREAS. IN AREAS WHERE NO UTILITIES ARE PRESENT, THE SUB-BASE SHALL BE INSTALLED WITHIN 15 DAYS OR PRELIMINARY GRADING.
- 7. IMMEDIATELY FOLLOWING INITIAL DISTURBANCE OR ROUGH GRADING ALL CRITICAL AREAS SUBJECT TO EROSION (I.E.: STEEP SLOPES, ROADWAY EMBANKMENTS) WILL RECEIVE A TEMPORARY SEEDING IN COMBINATION WITH STRAW MULCH OR A SUITABLE EQUIVALENT, AT A RATE OF TWO (2) TONS PER ACRE, ACCORDING TO THE NJ STATE STANDARDS.
- 8. ANY STEEP SLOPES RECEIVING PIPELINE INSTALLATION WILL BE BACKFILLED AND STABILIZED DAILY, AS THE INSTALLATION PROCEEDS (I.E.: SLOPES GREATER THAT 3:1)
- 9. TRAFFIC CONTROL STANDARDS REQUIRE THE INSTALLATION OF A 50'X30'X6"PAD OF 1 1/2" OR 2" STONE, AT ALL CONSTRUCTION DRIVEWAYS, IMMEDIATELY AFTER INITIAL SITE DISTURBANCE.
- 10. AT THE TIME WHEN THE SITE PREPARATION FOR PERMANENT VEGETATIVE STABILIZATION IS GOING TO BE ACCOMPLISHED, ANY SOIL THAT WILL NOT PROVIDE A SUITABLE ENVIRONMENT TO SUPPORT ADEQUATE VEGETATIVE GROUND COVER, SHALL BE REMOVED OR TREATED IN SUCH A WAY THAT WILL PERMANENTLY ADJUST THE SOIL CONDITIONS AND RENDER IT SUITABLE FOR VEGETATIVE GROUND COVER. IF THE REMOVAL OR TREATMENT OF THE SOIL WILL NOT PROVIDE SUITABLE CONDITIONS, NON-VEGETATIVE MEANS OF PERMANENT GROUND STABILIZATION WILL HAVE TO BE EMPLOYED.
- 11. IN THAT NJSA 4:24-39 ET SEQ., REQUIRES THAT NO CERTIFICATE OF OCCUPANCY BE ISSUED BEFORE THE PROVISIONS OF THE CERTIFIED PLAN FOR SOIL EROSION AND SEDIMENT CONTROL HAVE BEEN COMPLIED WITH FOR PERMANENT MEASURES, ALL SITE WORK FOR SITE PLANS AND ALL WORK AROUND INDIVIDUAL LOTS IN SUBDIVISIONS, WILL HAVE TO BE COMPLETED PRIOR TO THE DISTRICT ISSUING A REPORT OF COMPLIANCE FOR THE ISSUANCE OF A CERTIFICATE OF OCCUPANCY BY THE MUNICIPALITY.
- 12. CONDUIT OUTLET PROTECTION MUST BE INSTALLED AT ALL REQUIRED OUTFALLS PRIOR TO THE DRAINAGE SYSTEM BECOMING OPERATIONAL.
- 13. ANY CHANGES TO THE CERTIFIED SOIL EROSION AND SEDIMENT CONTROL PLAN WILL REQUIRE THE SUBMISSION OF REVISED SOIL EROSION AND SEDIMENT CONTROL PLANS TO THE DISTRICT FOR RE-CERTIFICATION. THE REVISED PLANS MUST MEET ALL CURRENT NJ STATE SOIL EROSION & SEDIMENT CONTROL STANDARDS.
- 14. THE SOMERSET-UNION SOIL CONSERVATION DISTRICT SHALL BE NOTIFIED OF ANY CHANGES
- 15. MULCHING TO THE NJ STANDARDS IS REQUIRED FOR OBTAINING A CONDITIONAL REPORT OF
- COMPLIANCE. CONDITIONALS ARE ONLY ISSUED WHEN THE SEASON PROHIBITS SEEDING. 16. CONTRACTOR IS RESPONSIBLE FOR KEEPING ALL ADJACENT ROADS CLEAN DURING LIFE OF
- 17. THE DEVELOPER SHALL BE RESPONSIBLE FOR REMEDIATING ANY EROSION OR SEDIMENT PROBLEMS THAT ARISE AS A RESULT OF ONGOING CONSTRUCTION AT THE REQUEST OF THE SOMERSET-UNION SOIL CONSERVATION DISTRICT.
- 18. HYDRO SEEDING IS A TWO- STEP PROCESS. THE FIRST STEP INCLUDES SEED, FERTILIZER LIME, ETC., ALONG WITH MINIMAL AMOUNTS OF MULCH TO PROMOTE CONSISTENCY, GOOD SEED TO SOIL CONTACT, AND GIVE A VISUAL INDICATION OF COVERAGE. UPON COMPLETION OF SEEDING OPERATION, HYDRO-MULCH SHOULD BE APPLIED AT A RATE OF 1500 LBS. PER ACRE IN SECOND STEP. THE USE OF HYDRO-MULCH, AS OPPOSED TO STRAW, IS LIMITED TO OPTIMUM SEEDING DATES AS LISTED IN THE NJ STANDARDS.
- 19. UNFILTERED DEWATERING IS NOT PERMITTED. NECESSARY PRECAUTIONS MUST BE TAKEN DURING ALL DEWATERING OPERATIONS TO MINIMIZE SOIL TRANSFER. ANY DEWATERING METHODS USED MUST BE IN ACCORDANCE WITH THE STANDARD FOR DEWATERING.

TOPSOIL STOCKPILE PROTECTION: (APPLY DURING GROWING SEASON)

- A) APPLY GROUND LIMESTONE AT A RATE OF 90 LBS. PER 1000 SQ. FT.
- B) APPLY FERTILIZER (10-20-10) AT A RATE 11 LBS. PER 1000 SQ. FT.
- C) APPLY PERENNIAL RYEGRASS SEED AT 1 LB. PER 1000 SQ. FT AND ANNUAL RYEGRASS AT 1 LB. PER 1000 SQ. FT.
- D) MULCH STOCKPILE WITH STRAW OR HAY AT A RATE OF 90 LBS. PER 1000 SQ. FT.
- E) APPLY A LIQUID MULCH BINDER OR TACK TO STRAW OR HAY MULCH F) PROPERTY ENTRENCH A SILT FENCE AT THE BOTTOM OF THE STOCKPILE.

TEMPORARY STABILIZATION SPECIFICATIONS: (APPLY DURING GROWING SEASON)

- A) APPLY GROUND LIMESTONE AT A RATE OF 90 LBS. PER 1000 SQ. FT.
- B) APPLY FERTILIZER (10-20-10) AT A RATE 11 LBS. PER 1000 SQ. FT. C) APPLY PERENNIAL RYEGRASS SEED AT 1 LB. PER 1000 SQ. FT AND ANNUAL RYEGRASS
- AT 1 LB. PER 1000 SQ. FT.
- D) MULCH STOCKPILE WITH STRAW OR HAY AT A RATE OF 90 LBS. PER 1000 SQ. FT. E) APPLY A LIQUID MULCH BINDER OR TACK TO STRAW OR MAY MULCH

- PERMANENT STABILIZATION SPECIFICATIONS: (APPLY DURING GROWING SEASON) A) APPLY TOPSOIL TO A DEPTH OF 5 INCHES (UNSETTLED)
- B) APPLY GROUND LIMESTONE AT A RATE OF 90 LBS. PER 1000 SQ. FT. AND WORK FOUR INCHES INTO SOIL C) APPLY FERTILIZER (10-20-00) AT A RATE 11 LBS. PER 1000 SQ. FT.
- D) APPLY HARD FESCUE SEED AT 2.7 LBS. PER 1000 SQ. FT. AND CREEPING RED FESCUE SEED AT 0.7 LBS.
- PER 1000 SQ. FT. AND PERENNIAL RYEGRASS SEED AT 0.25 LBS. PER 1000 SQ. FT.
- E) MULCH STOCKPILE WITH STRAW OR HAY AT A RATE OF 90 LBS PER 1000 SQ. FT. F) APPLY A LIQUID MULCH BINDER OR TACK TO STRAW OR HAY MULCH.

SEEDING FOR NON-GROWING SEASON STABILIZATION:

- A) APPLY GROUND LIMESTONE AT A RATE OF 90 LBS. PER 1000 SQ. FT.
- B) APPLY FERTILIZER (10-20-10) AT A RATE 11 LBS. PER 1000 SQ. FT. C) MULCH WITH UNROTTED SMALL-GRAIN STRAW OR SALT HAY AT 2 TONS PER ACRE
- SPREAD UNIFORMLY AT 90 LBS. PER 1000 SQ. FT.
- D) APPLY A LIQUID MULCH BINDER SUCH AS ORGANIC AND VEGETABLE BASED BINDERS OR SYNTHETIC BINDERS IMMEDIATELY AFTER SEEDING. APPLY AT RATES AND WEATHER CONDITIONS RECOMMENDED BY THE MANUFACTURER.

REQUIREMENTS FOR DUST CONTROL:

- 1. CONTRACTOR SHALL EMPLOY MEASURES TO CONTROL BLOWING AND MOVEMENT OF DUST FROM EXPOSED SOIL SURFACES, AS NECESSARY.
- 2. METHODS FOR CONTROLLING DUST SHALL INCLUDE MULCHES, VEGETATIVE COVER, SPRAY-ON ADHESIVES,
- TILLAGE, SPRINKLING, BARRIERS, CALCIUM CHLORIDE, AND STONE COVER. 3. DUST CONTROLS SHALL COMPLY WITH STANDARDS FOR SOIL EROSION AND SEDIMENT CONTROL IN NEW JERSEY.

SEQUENCE OF CONSTRUCTION

10. REMOVE ALL TEMPORARY SOIL EROSION MEASURES

14

240



OPENING ABOVE 2"X4" FOR INLET FILTER INSTALLATION WITHOUT FRAME & GRATE GREATER THAN 1 YEAR STORM MOLD WELDED WIRE FOR EXISTING INLET STRUCTURES, PLACE GEOTEXTILE FABRIC WITHOUT SUPPORT AROUND INLET WELDED WIRE SUPPORT UNDER FRAME AND GRATE EXTEND 6" MIN. AT SIDES (4" WOODEN AFTER INSTALLATION OF GEOTEXTILE, BACKFILL WITH NO. 8 COARSE AGGREGATE TO SECURE GEOTEXTILE TO **NEW CONSTRUCTION**


SECURE FABRIC IN

EXISTING INLET

B-TYPE INLET FILTER N.T.S.

WOOD FRAME CONSTRUCTED OF 2"x4" STUD GRADE LUMBER _ _ JOINED AT EACH CORNER WITH TWO (2) 10d NAILS FILTER FABRIC ON TOP OF GRATE & TUCK UNDER SIDES WRAP FILTER FABRIC AROUND IN BETWEEN FRAME & GRATE AND SECURE TO 2"x4" LUMBER WITH 3/8" (MIN.) STAPLES 3' C-C IN A STAGGERED PATTERN **CONSTRUCTION NOTES:** ON BOTH SIDES 1. FILTER TO REMAIN UNTIL COMPLETION OF FINAL GRADING AND ESTABLISHMENT OF COVER, ALSO PERIODIC CHECKS MUST BE MADE AFTER EACH RAINFALL TO EXCAVATE AND REMOVE EXCESS SEDIMENT FROM WRAP FILTER FABRIC AROUND AND SECURE TO 2"x4" LUMBER AROUND INLETS. WITH 3/8" (MIN.) STAPLES 3" 2. FILTER FABRIC SHALL BE ---- 140N C-C IN A STAGGERED PATTERN OR APPROVED EQUIVALENT. ON BOTH SIDES FRAME AND GRATE FILTER FABRIC ON TOP OF GRATE & TUCK UNDER SIDES INLET STRUCTURE IN BETWEEN FRAME & GRATE SECTION D-D SECTION C-C

A OR E-TYPE INLET FILTER

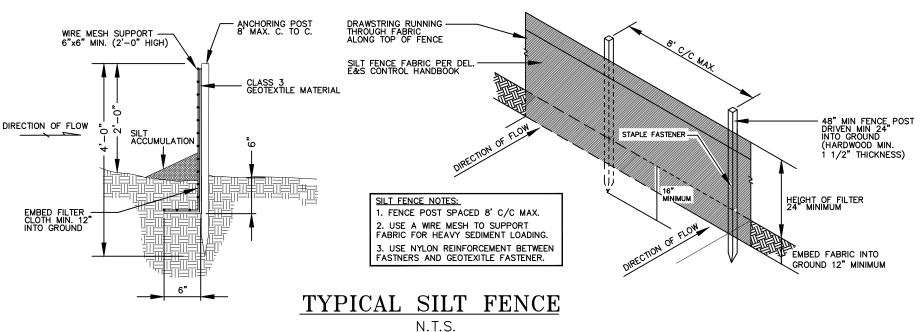

SOIL DE-COMPACTION AND TESTING REQUIREMENTS

SOIL COMPACTION TESTING REQUIREMENTS

- 1. SUBGRADE SOILS **PRIOR TO THE APPLICATION OF TOPSOIL** (SEE PERMANENT SEEDING AND STABILIZATION NOTES FOR TOPSOIL REQUIREMENTS) SHALL BE FREE OF EXCESSIVE COMPACTION TO A DEPTH OF 6.0 INCHES TO ENHANCE THE ESTABLISHMENT OF PERMANENT VEGETATIVE COVER.
- 2. AREAS OF THE SITE WHICH ARE SUBJECT TO COMPACTION TESTING AND/OR MITIGATION ARE **GRAPHICALLY DENOTED** ON THE CERTIFIED SOIL EROSION CONTROL
- COMPACTION TESTING LOCATIONS ARE DENOTED ON THE PLAN. A COPY OF THE PLAN OR PORTION OF THE PLAN SHALL BE USED TO MARK LOCATIONS OF TESTS, AND ATTACHED TO THE COMPACTION REMEDIATION FORM, AVAILABLE FROM THE LOCAL SOIL CONSERVATION DISTRICT. THIS FORM MUST BE FILLED OUT AND SUBMITTED PRIOR TO RECEIVING A CERTIFICATE OF COMPLIANCE FROM THE DISTRICT.
- 4. IN THE EVENT THAT TESTING INDICATED COMPACTION IN EXCESS OF THE MAXIMUM THRESHOLDS INDICATED FOR THE SIMPLIFIED TESTING METHODS (SEE DETAILS BELOW), THE CONTRACTOR/OWNER SHALL HAVE THE OPTION TO PERFORM EITHER (1) COMPACTION MITIGATION OVER THE ENTIRE MITIGATION AREA DENOTED ON THE PLAN (EXCLUDING EXEMPT AREAS), OR (2) PERFORM ADDITIONAL, MORE DETAILED TESTING TO ESTABLISH THE LIMITS OF EXCESSIVE COMPACTION WHEREUPON ONLY THE EXCESSIVELY COMPACTED AREAS WOULD REQUIRE COMPACTION MITIGATION. ADDITIONAL DETAILED TESTING SHALL BE PERFORMED BY A TRAINED, LICENSED

COMPACTION TESTING METHODS

- A. PROBING WIRE TEST (SEE DETAIL) B. HAND-HELD PENETROMETER TEST (SEE DETAIL)
- C. TUBE BULK DENSITY TEST (LICENSED PROFESSIONAL ENGINEER REQUIRED) N. NUCLEAR DENSITY TEST (LICENSED PROFESSIONAL ENGINEER REQUIRED)
- NOTE: ADDITIONAL TESTING METHODS WHICH CONFORM TO ASTM STANDARDS AND SPECIFICATIONS, AND WHICH PRODUCE A DRY WEIGHT, SOIL BULK DENSITY


SOIL COMPACTION TESTING NOT REQUIRED IF/WHEN SUBSOIL COMPACTION REMEDIATION (SCARIFICATION/TILLAGE (6" MINIMUM DEPTH OR SIMILAR) IS PROPOSED AS PART OF SEQUENCE OF CONSTRUCTION.

PROCEDURES FOR SOIL COMPACTION MITIGATION

MEASUREMENT MAY BE ALLOWED SUBJECT TO DISTRICT APPROVAL.

PROCEDURES SHALL BE USED TO MITIGATE EXCESSIVE SOIL COMPACTION PRIOR TO PLACEMENT OF TOPSOIL AND ESTABLISHMENT OF PERMANENT VEGETATIVE COVER


RESTORATION OF COMPACTED SOILS SHALL BE THROUGH DEEP SCARIFICATION/TILLAGE (6" MINIMUM DEPTH) WHERE THERE IS NO DANGER TO UNDERGROUND UTILITIES CABLES, IRRIGATION SYSTEMS, ETC.). IN THE ALTERNATIVE ANOTHER METHOD AS SPECIFIED BY A NEW JERSEY LICENSED PROFESSIONAL ENGINEER MAYBE SUBSTITUTED SUBJECT TO DISTRICT APPROVAL.

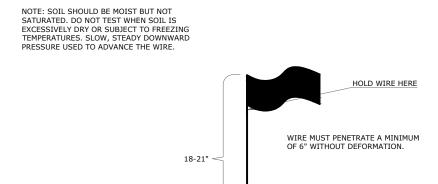

WIRE MAY BE RE-INSERTED IF/WHEN AN OBSTRUCTION (ROCK, ROOT, DEBRIS) IS ENCOUNTERED.

PROBING WIRE TEST - 15.5 GA STEEL WIRE (SURVEY FLAG) N.T.S.

ON WIRE AT DEPTH

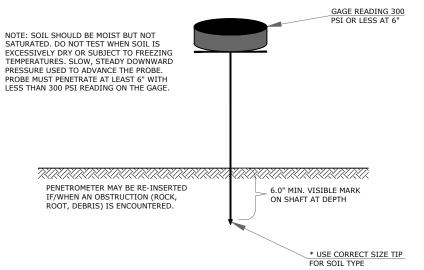

HANDHELD SOIL PENETROMETER TEST

SCHEDULE OF REVISIONS DATE DESCRIPTION OF CHANGES

OWNER/APPLICANT YESHIVA TIFERES BORUCH, INC. 112 LINDEN AVENUE NORTH PLAINFIELD, NJ 07060

E 2 PROJECT MANAGEMENT LLC

87 HTRFRNTA AVFNUF ROCKAWAY, N.J. 07866 PHONE: (973) 299-5200 FAX: (973) 299-5059 www.E2PM.com

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N.J. ENGINEERING CERTIFICATE OF AUTHORIZATION No. 24GA28118200

> I CERTIFY THAT THESE PLANS HAVE BEEN PREPARED UNDER MY SUPERVISION

CHARLES J. STEWART, P.E., P.L.S. N.J. NO. 24GB03588400 REGISTERED PROFESSIONAL ENGINEER AND LAND SURVEYOR

YESHIVA NEW ACADEMY BUILDING

TAX LOT 1 BLOCK 134


21 ROCKVIEW AVENUE BOROUGH OF NORTH PLAINFIELD SOMERSET COUNTY, NJ

DRAWING TITLE

SOIL EROSION AND SEDIMENT CONTROL DETAILS


CHECKED BY: CS DRAWN BY: ENS SHEET NO: 12 OF 15 AS NOTED FIRST ISSUE: 8/24/2022 PROJECT #: P-22-47-01 DRAWING NO.

C-100.00

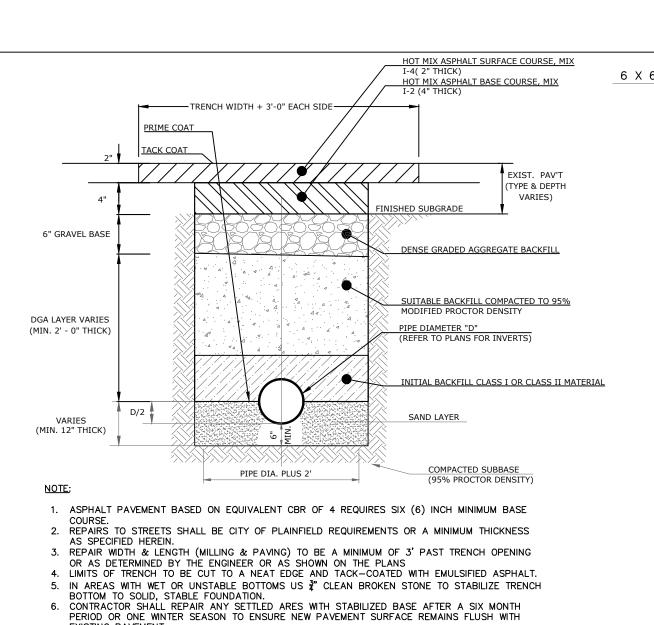


\C-101/


PIPE TRENCH (R.O.W. SCALE: N.T.S PAVEMENT SECTION VARIES

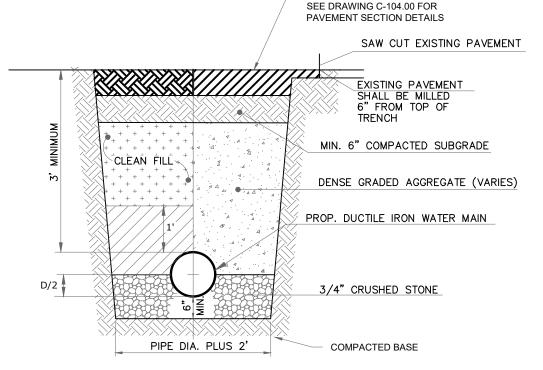


- 1. LIMITS OF TRENCH TO BE CUT TO A NEAT EDGE AND TACK-COATED WITH EMULSIFIED ASPHALT.
- 2. IN AREAS WITH WET OR UNSTABLE BOTTOMS USE 3/4" CLEAN BROKEN STONE TO STABILIZE TRENCH BOTTOM
- 3. CONTRACTOR SHALL REPAIR ANY SETTLED AREAS WITH STABILIZED BASE AFTER A SIX MONTH PERIOD OR ONE WINTER SEASON TO ENSURE NEW PAVEMENT SURFACE
- REMAINS FLUSH WITH EXISTING PAVEMENT. 4. REFER TO DRAWING C-104.00 FOR PAVEMENT THICKNESS

PIPE TRENCH (ON SITE)

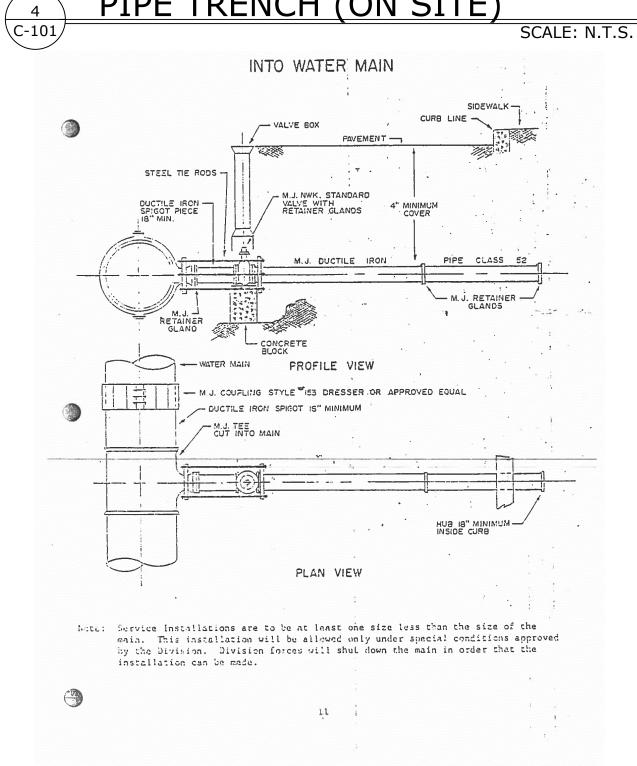


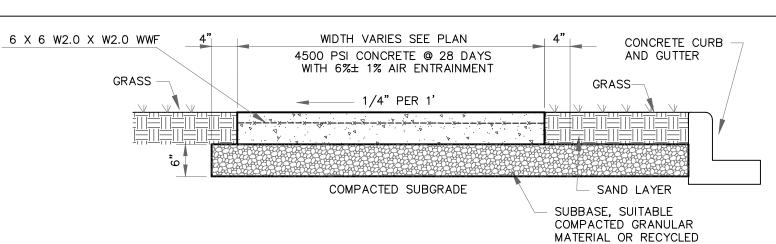

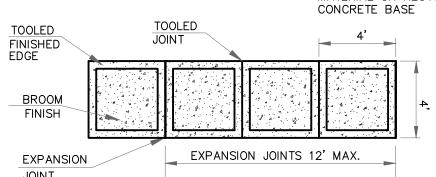


- 1. ANY CONCRETE PLACED BETWEEN NOVEMBER 15 AND APRIL 1 MUST CONFORM TO ARTICLES 501.11 AND 501.17 OF THE N.J.D.O.T. STANDARD SPECIFICATIONS FOR ROAD AND BRIDGE CONSTRUCTION, 1989 EDITION, USING 2% CALCIUM CHLORIDE, HOT WATER, COVERED W/SALT HAY.
- 2. WHERE SIDEWALK ABUTS CURBING, INSTALL EXPANSION JOINT BETWEEN CURB AND SIDEWALK ALONG ENTIRE LENGTH. 3. SLUMP TEST: 3"- 4".
- EXPANSION JOINTS EVERY 12', CONSTRUCTION JOINTS EVERY 4' AT A DEPTH OF 1/4 THICKNESS OF CONCRETE. 5. ALL SIDEWALK MUST BE SPRAYED WITH WHITE PIGMENTED CURING COMPOUND

SIDEWALK

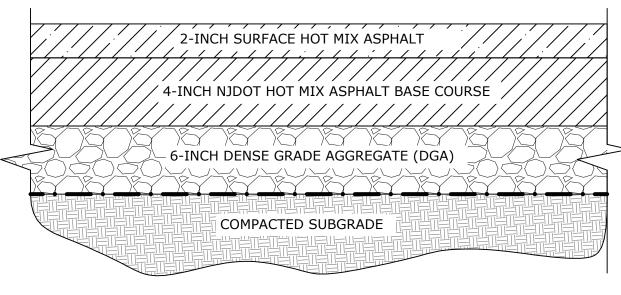

ASPHALT PAVEMENT

SCALE: N.T.S.

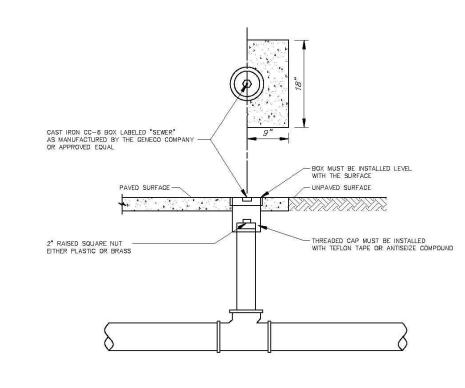

1. AT LEAST ONE CLEANOUT MUST BE PROVIDED ON EACH LATERAL.

- 2. A CLEANOUT WILL BE PROVIDED FOR EACH LATERAL BETWEEN THE CURB AND THE SIDEWALK. 3. IN GENERAL, OWNERSHIP AND MAINTENANCE OF LATERALS AND CLEANOUTS WILL BE THE RESPONSIBILITY OF THE PROPERTY OWNER.
- 4. THE LOCATION OF ALL CLEANOUTS MUST BE APPROVED BY THE TOWNSHIP PLUMBING DEPARTMENT.


5. ALL CLEANOUTS LOCATED WITHIN PAVEMENT OR CONCRETE MUST BE PROTECTED WITH A CC-6 BOX.

CLEANOUT

SCALE: N.T.S

OWNER/APPLICANT YESHIVA TIFERES BORUCH, INC. 112 LINDEN AVENUE NORTH PLAINFIELD, NJ 07060




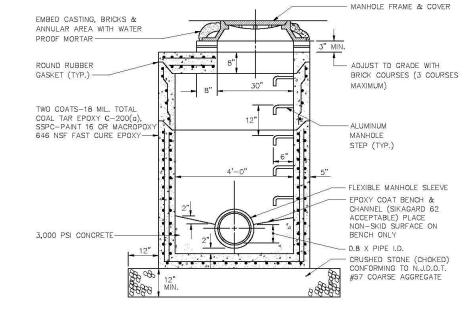

- 1. INTERIOR SURFACES TO BE COATED WITH TWO COATS, 18 MIL TOTAL, COAL TAR EPOXY MEETING SPECIFICATION C-200(A) OR SSPC-PAINT 16 IF RECEIVING DIRECT DISCHARGE FROM PUMP STATION OR DIFFERENCE IN INVERT ELEVATIONS EXCEEDS 12".
- 2. RISER, CONES AND SLABS SHALL BE CONSTRUCTED IN ACCORDANCE WITH A.S.T.M. C-478.


7. CAN ONLY BE USED AT DEPTHS GREATER THAN 6.5' AS MEASURED FROM RIM TO INVERT.

- 3. NON PENETRATING LIFTING HOLES SHALL BE PROVIDED IN ALL UNITS. 4. ABSORPTION NOT TO EXCEED 8% IN ACCORDANCE WITH A.S.T.M. C-76.
- 5. ALL JOINTS TO BE CONSTRUCTED IN ACCORDANCE WITH A.S.T.M. C-361.
- 6. NO PRE-CAST BENCHES OR CHANNELS

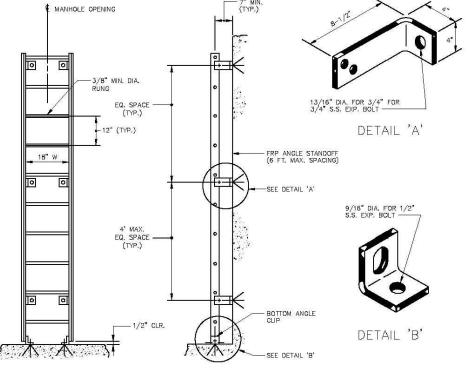

- NOTES:
- 1. LADDERS SHALL BE INSTALLED ON ALL MANHOLES WHERE THE DISTANCE FROM THE INVERT TO
- 2. LADDER SHALL BE FIBERGLASS. 3. CLIPS, ANGLES, BOLTS, WASHERS AND ALL OTHER HARDWARE SHALL BE 304 STAINLESS STEEL.
- 4. ALL MANHOLES EXCEEDING 25 FEET FROM INVERT TO RIM SHALL HAVE AT LEAST ONE INTERMEDIATE

FIBERGLASS MANHOLE LADDER

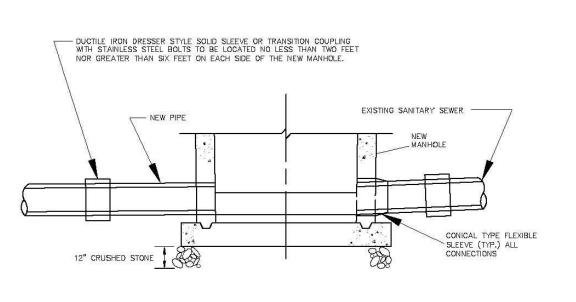

- 1. BENCH TO HAVE 2.0% SLOPE (TYP.) WITH NON SKID SURFACE.
- 2. ALL CONNECTIONS TO BE MADE WITH CONICAL TYPE FLEXIBLE SEAL SUCH AS KOR-N-SEAL OR EQUAL.
- 3. ALL CHANNELS MUST BE HALF PIPE OR EPOXY COATED.
- 4. THE MANHOLE MUST MEET ALL REQUIREMENTS FOR MANHOLE CONSTRUCTION SHOWN ON THE OTHER DETAILS OF THE AUTHORITY INCLUDING BUT NOT LIMITED TO THE REQUIREMENT FOR 12" OF CRUSHED STONE TO BE PLACED UNDER THE NEW MANHOLE.

DOGHOUSE MANHOLE

SCALE: N.T.S.

87 HIBERNIA AVENU ROCKAWAY, N.J. 07866 PHONE: (973) 299-5200 www.E2PM.com

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E 2 PROJECT MANAGEMENT LLC

SCHEDULE OF REVISIONS

DATE DESCRIPTION OF CHANGES

N.J. ENGINEERING CERTIFICATE OF AUTHORIZATION No. 24GA28118200

> I CERTIFY THAT THESE PLANS HAVE BEEN PREPARED UNDER MY SUPERVISION

CHARLES J. STEWART, P.E., P.L.S. N.J. NO. 24GB03588400 REGISTERED PROFESSIONAL ENGINEER AND LAND SURVEYOR

PROJECT NAME

YESHIVA NEW ACADEMY BUILDING

> TAX LOT 1 BLOCK 134

21 ROCKVIEW AVENUE BOROUGH OF NORTH PLAINFIELD SOMERSET COUNTY, NJ

DRAWING TITLE

DRAWING NO.


CONSTRUCTION DETAILS

CHECKED BY:	CS	DRAWN BY: E	NS
SCALE:	AS NOTED	SHEET NO: 13	OF 15
PROJECT #: P-2	2-47-01	FIRST ISSUE:	8/24/2022

C-101.00



SCALE: N.T.S.

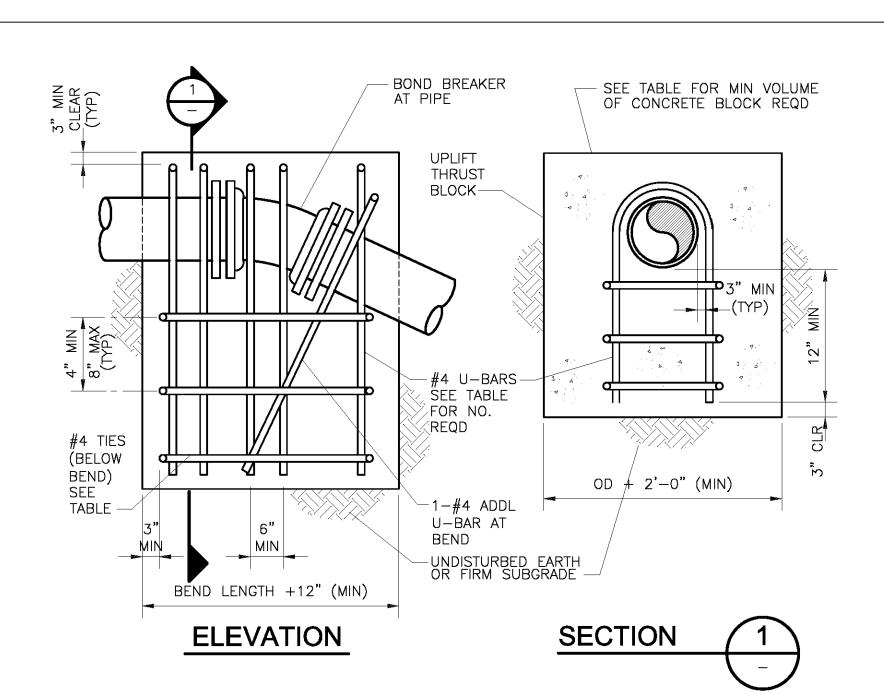

PIPE	PIPE, Q.D.	60	DEG	45 DEG		30 DEG		22.5 DEG		#4 TIES REQD	
SIZĒ (IN.)	(īn.)	REINF	CONC	REINF	CONC	REINF	CONC	REINF	CONC	#4 HES REQU	
3	3.96	2	1	2	0.5	2	0.5	2	0.5	2	
4	4.80	2	1	2	1.0	2	0.5	2	0.5	2	
6	6.90	2	2	2	1.5	2	1.0	2	1.0	2	
8	9.05	2	3.5	2	3	2	2	2	1.5	2	
10	11.10	2	5	2	4	2	3	2	2.0	2	
12	13.20	3	7	3	6	2	4	2	3	2	
14	15.30	4	9	4	7	3	5	2	4	4	
16	17.40	6	12	5	10	3	7	3	5	4	
18	19.50	7	15	6	12	4	9	3	7	4	


C-102

- 1. "REINF" = NO. OF #4-U-BARS REQUIRED.
- 2. "CONCRETE" = VOLUME OF CONCRETE BLOCK REQUIRED, CU YD. 3. MAXIMUM TEST PRESSURE = 1.50x1.50 PSI.

CONCRETE THRUSTBLOCK FOR VERTICAL BENDS

CAMPBELL FDRY NO. 1202


4. MINIMUM GRADE 40 REBAR.

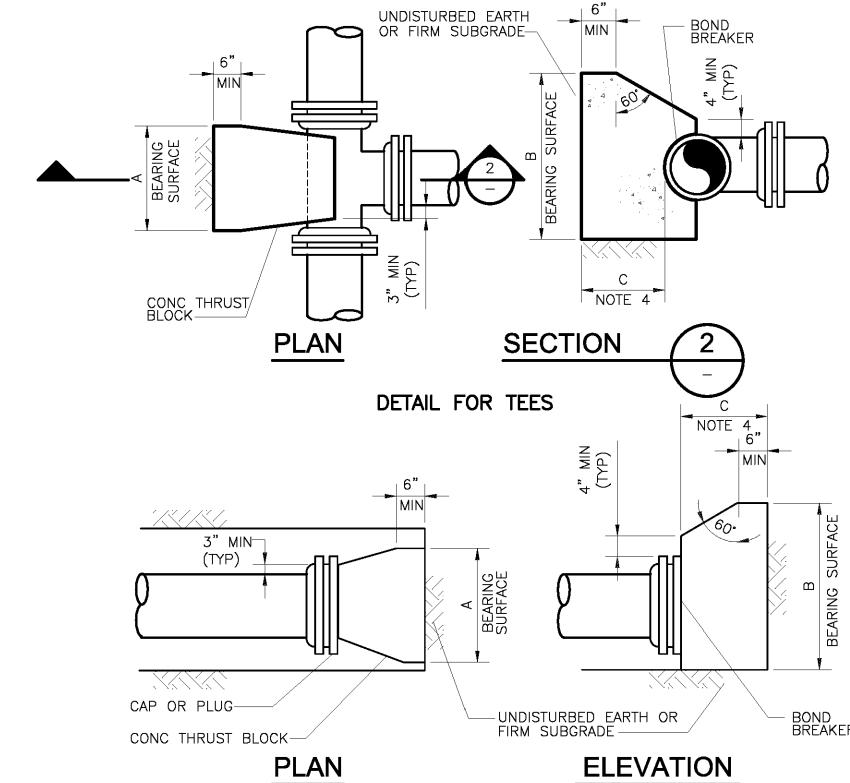


DETAIL FOR CAPS OR PLUGS

NOMINAL PIPE SIZE (IN)	MAXIMUM PIPE OD (IN)	REQUIRED BEARING AREA (SQ FT)
3	3.96	1.4
4	4.80	2.0
6	6.90	4
8	9.05	7
10	11.10	11
12	13.20	15
14	15.30	21
16	17.40	27
18	19.50	34
20	21.60	41
24	25.80	59
30	32.00	90
36	38.30	130

- 1. MAXIMUM TEST PRESURE = 1.50x150 PSI 2. MINIMUM ALLOWABLE SOIL BEARING PRESSURE = 2000 PSF
- 3. BEARING AREA = $A \times B$
- 4. C SHALL BE GREATER THAN A/2 AND B/2.

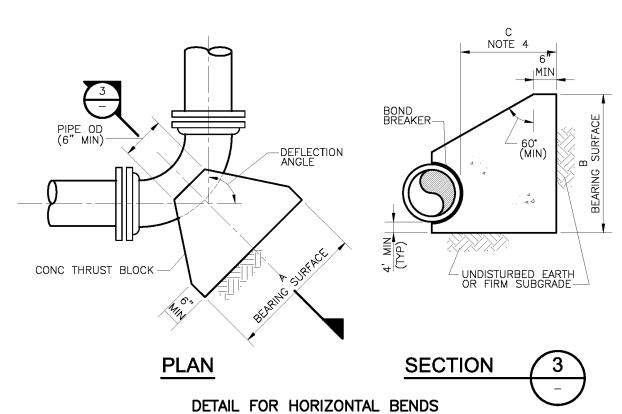

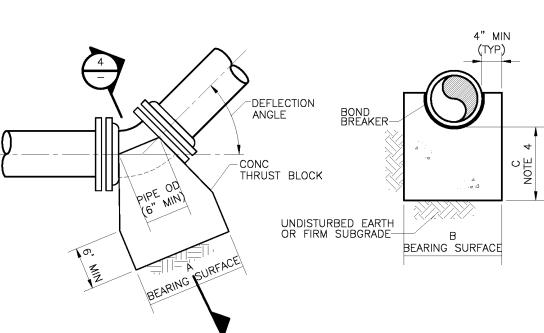

DETAIL FOR LOWER VERTICAL BENDS

SECTION

ELEVATION

NOMINAL PIPE SIZE	MAXIMUM PIPE OD		REQU	IRED BEARING AREA (SQ FT)				
PIPE SIZE (INCHES)	PIPE OD (INCHES)	90 DEG	60 DEG	45 DEG	30 DEG	22.50 DEG	11.25 DEG	
3	3.96	2.0	1.4	1.1	0.7	0.5	0.3	
4	4.80	2.9	2.0	1.6	1.1	0.8	0.4	
6	6.90	6	4	3	2.2	1.6	0.8	
8	9.05	10	7	6	4	3	1.4	
10	11.10	15	11	8	6	4	2.1	
12	13.20	22	15	12	8	6	3	
14	15.30	29	21	16	11	8	4	
16	17.40	38	27	20	14	10	5	
18	19.50	48	34	26	17	13	7	
20	21.60	58	41	32	21	16	8	
24	25.80	83	59	45	30	23	12	
30	32.00	128	90	69	47	35	18	
36	38.30	183	130	99	67	51	25	

THRUST BLOCKS FOR HORIZONTAL BENDS AND LOWER VERTICAL BENDS

CONCRETE THRUSTBLOCK FOR HORIZONTAL BENDS

- 1. MAXIMUM TEST PRESURE = 1.5 x 150 PSI 2. MINIMUM ALLOWABLE SOIL BEARING PRESSURE = 2000 PSF
- 3. BEARING AREA = $A \times B$ 4. C SHALL BE GREATER THAN A/2 AND B/2.

FRAME AND GRATE

CAMPBELL FOUNDRY PATTERN

CONCRETE

CONCRETE OR

CONCRETE BLOCK

2'-10"

SECTION B-B

SCALE: N.T.S.

No. 3412 OR EQUIVALENT

4'-0" 6" OR

YESHIVA TIFERES BORUCH, INC.

NORTH PLAINFIELD, NJ 07060


OWNER/APPLICANT

112 LINDEN AVENUE

E 2 PROJECT MANAGEMENT LLC

SCHEDULE OF REVISIONS

REV. DATE DESCRIPTION OF CHANGES

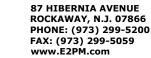

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YESHIVA NEW ACADEMY BUILDING

TAX LOT 1 BLOCK 134

21 ROCKVIEW AVENUE BOROUGH OF NORTH PLAINFIELD SOMERSET COUNTY, NJ


DRAWING TITLE

CONSTRUCTION DETAILS

CHECKED BY:	CS	DRAWN BY: ENS
SCALE:	AS NOTED	SHEET NO: 14 OF 15
PROJECT #: P-2	22-47-01	FIRST ISSUE: 8/24/2022
DDAWING NO		

C-102.00

CONCRETE THRUSTBLOCK FOR TEES CAPS AND PLUGS

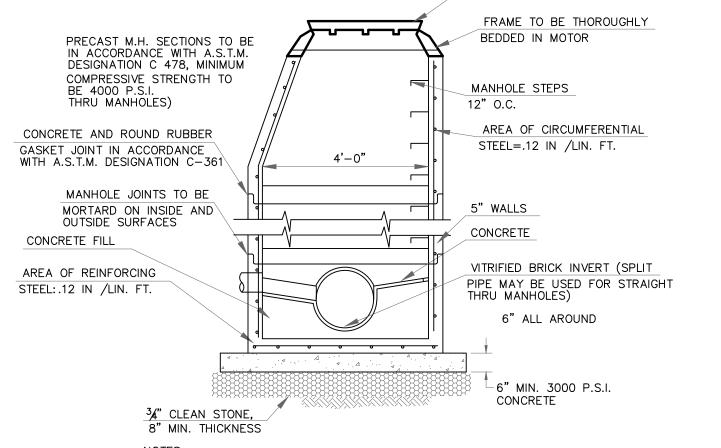

1. 12" COAT OF CEMENT MORTAR ON EXTERIOR AND PAINTED WITH BITUMASTIC PAINT. 2. INTERIOR TO BE RUBBED FINISH OR NEATLY STRUCK JOINTS. 3. MANHOLE COVERS SHALL BE CAST WITH THE WORDS SANITARY SEWER. 4. COVERS SHALL HAVE NON-PENETRATING PICKHOLES AND NO VENT HOLES.

ROOF LEADER DOWNSPOUT (REFER TO MEP AND ARCH. PLANS FOR INFORMATION) CONVEYANCE SYSTEM

STORM ROOFLEADER AND CLEANOUT

STORM MANHOLE

SCALE: N.T.S.


TYPE 'A' INLET


5'-0"

SECTION A-A

THOROUGHLY BED

FRAME IN MORTAR

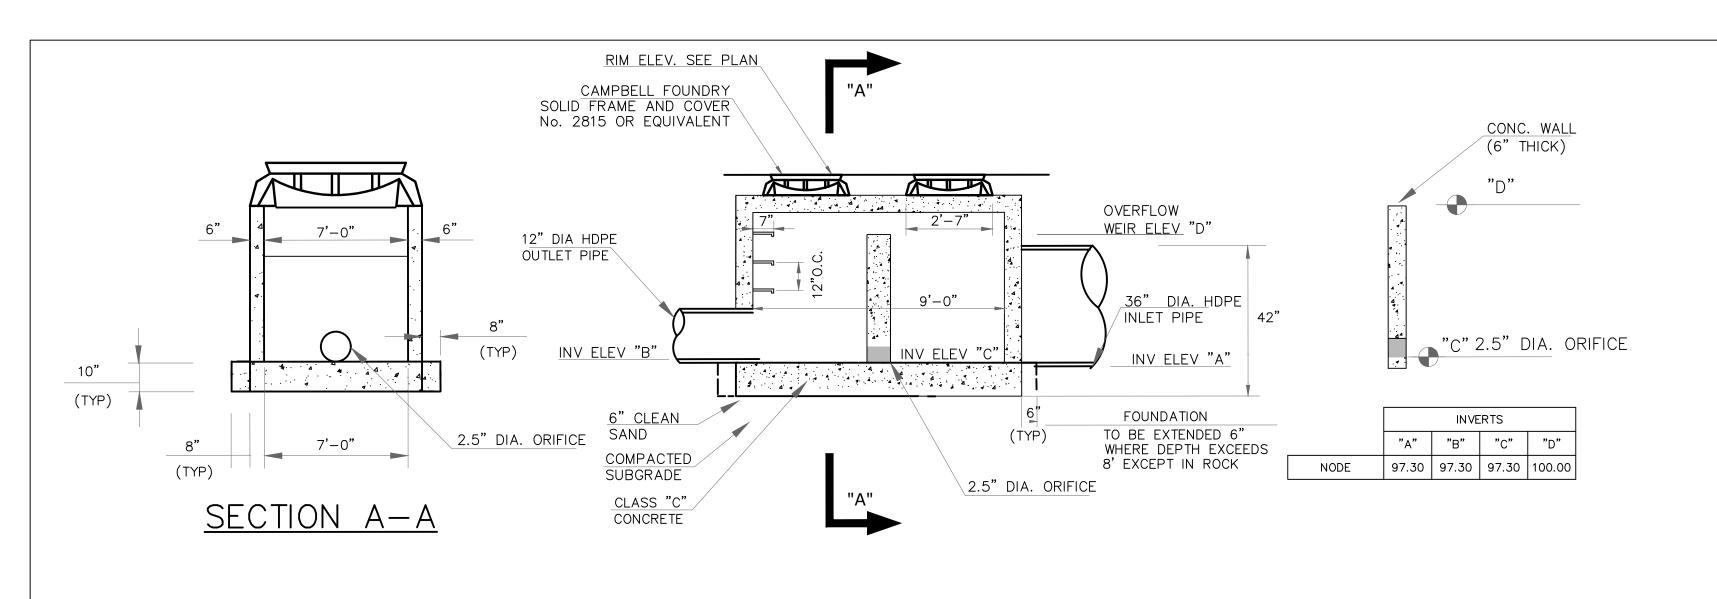


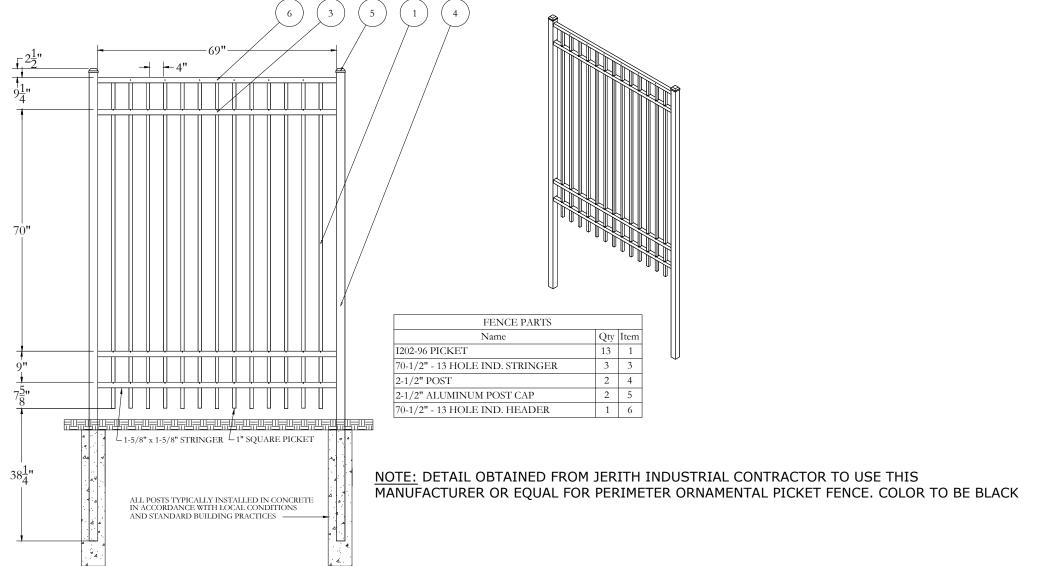

SCHEDULE OF REVISIONS DATE DESCRIPTION OF CHANGES

SCALE: N.T.S.

PERIMETER ORNAMENTAL PICKET FENCE

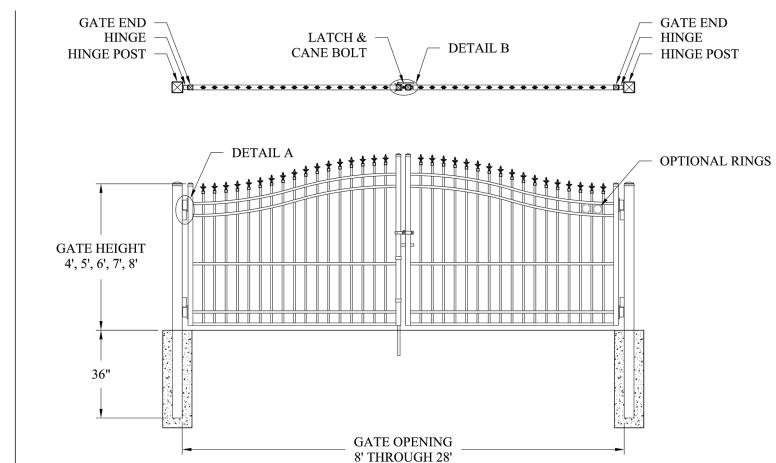

ESTATETM ALUMINUM ENTRY GATE

Ornamental Pickets: 3/4" Square x .125" Wall

Uprights: 2" Square x .250" Wall Rails: 1"x 2" x .250"Wall

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OWNER/APPLICANT

112 LINDEN AVENUE

YESHIVA TIFERES BORUCH, INC.

NORTH PLAINFIELD, NJ 07060

87 HIBERNIA AVENU

www.E2PM.com

ROCKAWAY, N.J. 07866

PHONE: (973) 299-5200

I CERTIFY THAT THESE PLANS HAVE BEEN PREPARED UNDER MY SUPERVISION

E 2 PROJECT MANAGEMENT LLC

CHARLES J. STEWART, P.E., P.L.S. N.J. NO. 24GB03588400

REGISTERED PROFESSIONAL ENGINEER AND LAND SURVEYOR

YESHIVA NEW ACADEMY BUILDING

TAX LOT 1 BLOCK 134

21 ROCKVIEW AVENUE BOROUGH OF NORTH PLAINFIELD SOMERSET COUNTY, NJ

DRAWING TITLE

CHECKED BY:	CS	DRAWN BY: ENS	
SCALE:	AS NOTED	SHEET NO: 15	OF 15
PROJECT #: P-22-47-01		FIRST ISSUE:	8/24/2022
DD 414/714 G 14 G			

C-103.00

OUTLET CONTROL STRUCTURE-1

(GRASS AREA)

FILTER FABRIC -(WHERE REQUIRED BY ENGINEER)

> * CLASS I OR II MATERIAL — PLACED AND COMPACTED IN

ASTM D2321 IN PIPE ZONE

1. ALL REFERENCES TO CLASS I OR II MATERIAL ARE PER ASTM D2321 "STANDARD PRACTICE FOR UNDERGROUND INSTALLATION OF THERMOPLASTIC PIPE FOR SEWERS AND OTHER GRAVITY

2. ALL RETENTION AND DETENTION SYSTEMS SHALL BE INSTALLED IN ACCORDANCE WITH ASTM D2321, LATEST EDITION AND THE MANUFACTURER'S PUBLISHED INSTALLATION GUIDELINES.

3. MEASURES SHOULD BE TAKEN TO PREVENT THE MIGRATION OF NATIVE FINES INTO THE

. FILTER FABRIC: A GEOTEXTILE FABRIC MAY BE USED AS SPECIFIED BY THE ENGINEER TO PREVENT THE MIGRATION OF FINES FROM THE NATIVE SOIL INTO THE SELECT BACKFILL

BY THE ENGINEER. AS AN ALTERNATIVE AND AT THE DISCRETION OF THE DESIGN ENGINEER, THE

BEDDING: SUITABLE MATERIAL SHALL BE CLASS I OR II. THE CONTRACTOR SHALL PROVIDE DOCUMENTATION FOR MATERIAL SPECIFICATION TO ENGINEER. UNLESS OTHERWISE NOTED BY

INITIAL BACKFILL: SUITABLE MATERIAL SHALL BE CLASS I OR II IN THE PIPE ZONE EXTENDING NOT LESS THAN 6" ABOVE CROWN OF PIPE. THE CONTRACTOR SHALL PROVIDE DOCUMENTATION

FOR MATERIAL SPECIFICATION TO ENGINEER. MATERIAL SHALL BE INSTALLED AS REQUIRED IN

. <u>MINIMUM COVER:</u> MINIMUM COVER OVER ALL RETNETION/DETENTION SYSTEMS IN NON-TRAFFIC APPLICATIONS (GRASS OR LANDSCAPE AREAS) IS 12" FROM TOP OF PIPE TO GROUND SURFACE.

ADDITIONAL COVER MAY BE REQUIRED TO PREVENT FLOATATION. FOR TRAFFIC APPLICATIONS,

MEASURED FROM TOP OF PIPE TO BOTTOM OF FLEXIBLE PAVEMENT OR TO TOP OF RIGID

MINIMUM COVER IS 12" UP TO 36" DIAMETER PIPE AND 24" OF COVER FOR 42" - 60" DIAMETER PIPE

ADS INFILTRATION BASIN

THE ENGINEER, MINIMUM BEDDING THICKNESS SHALL BE 4" (100mm) FOR 4"-24" (100mm-60

5. <u>FOUNDATION:</u> WHERE THE TRENCH BOTTOM IS UNSTABLE, THE CONTRACTOR SHALL EXCAVATE (300mm)
TO A DEPTH REQUIRED BY THE ENGINEER AND REPLACE WITH SUITABLE MATERIAL AS SPECIFIED

ACCORDANCE WITH

BACKFILL MATERIAL, WHEN REQUIRED. SEE ASTM D2321

6" (150mm) FOR 30"-60" (750mm-1500mm).

SINGLE SWING


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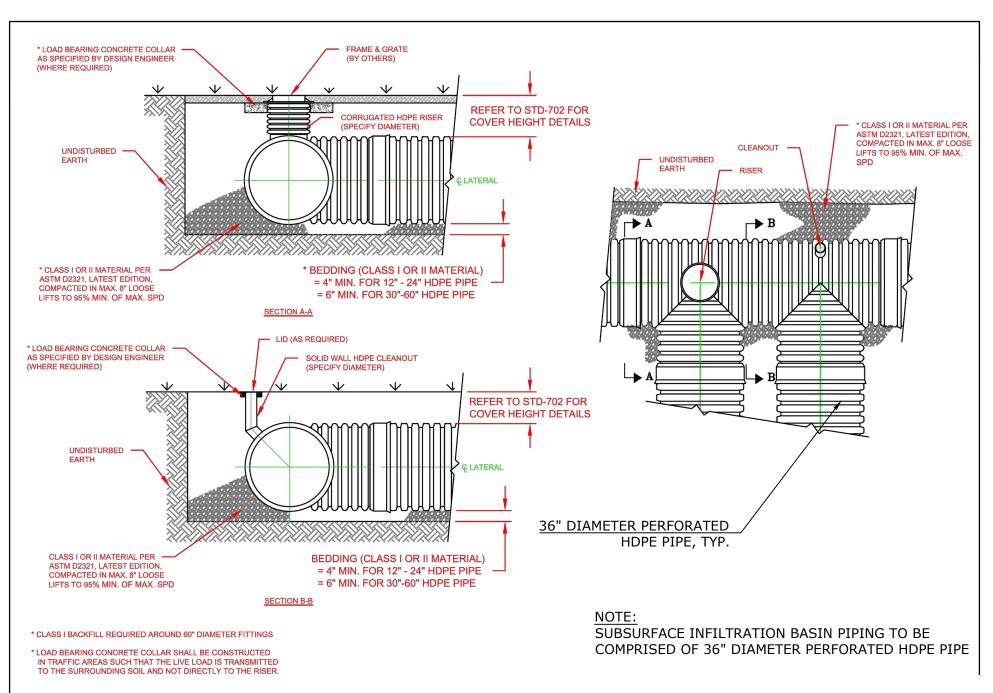
ASTM D2321, LATEST EDITION.

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TRENCH BOTTOM MAY BE STABILIZED USING A GEOTEXTILE MATERIAL.





SCALE: N.T.S

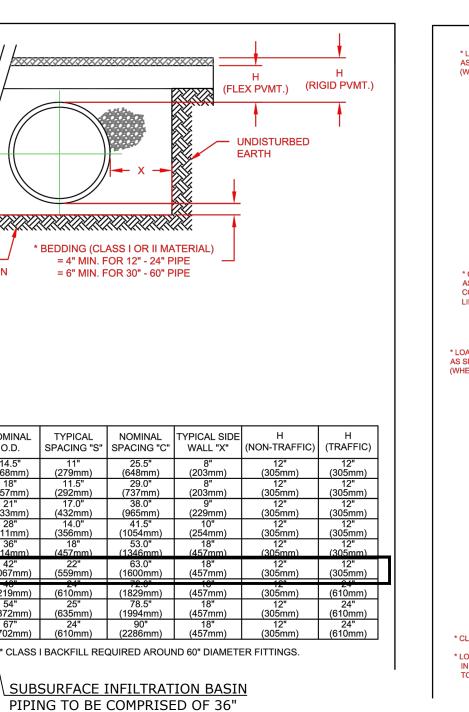FRONT VIEW SCALE: N.T.S.

DETAIL A

ADS INFILTRATION BASIN RISER



= 4" MIN. FOR 12" - 24" PIPE

= 6" MIN. FOR 30" - 60" PIPE

DIAMETER PERFORATED HDPE PIPE





DIMENSIONAL DRAWING

	OPENING	LEAF WIDTH	ITEM NUMBER	PICKET QTY	WEIGHT	STOCKING
6' HEIGHT	3'	34-¾"	LG72 <u>⊗</u> <u>⊠</u> 36AG	7	15 lbs	0
	4'	46-¾"	LG72 <u>⊗</u> <u>⊠</u> 48AG	9	17 lbs	0
	5'	58-¾"	LG72 <u>⊗</u> <u>⊠</u> 60AG	12	19 lbs	0

 $\underline{\otimes} = \textbf{COLOR OPTIONS AVAILABLE} \mid \underline{\mathbf{B}} = \text{Black } \underline{\mathbf{Z}} = \text{Bronze}$

 \boxtimes = FENCE STYLES AVAILABLE | 200 = #200 202 = #202 211 = #211 101 = #101 111 = #111

 $\bigcirc = NON-STOCKED PRODUCT$

ORNAMENTAL ARCHED SINGLE FENCE GATE

SCALE: N.T.S.

ORNAMENTAL ARCHED DOUBLE FENCE GATE

DETAIL A (optional)

BACK VIEW

Values shown are nominal and not to be used for installation purposes. See product specification for installation requirements.

FRONT VIEW

CONSTRUCTION DETAILS